RESERVED FOR REGISTRY USE ONLY

LAWRENCE WASTE SERVICES CORP. PROPOSED COMMERCIAL BUILDING

#39 ALDER STREET
MEDWAY, MA 02059
(ASSESSORS PARCEL 63 - 004)

PREPARED FOR - APPLICANT / OWNER

EAST HILL ASSOCIATES LLC 49 ALDER STREET MEDWAY, MA 02053

DISTRICT DIMENSIONAL	REGULATIONS
DISTRICT: WEST INDUSTRIAL	(WI)
USE: VACANT LAND (UNDEVE	LOPED)
	REQUIRED
MIN. LOT SIZE	40,000 S.F.
MIN. FRONTAGE	100'
MIN. FRONT YARD SETBACK	30'
MIN. SIDE YARD SETBACK	20'
MIN. REAR YARD SETBACK	30'
MAX. BUILDING HEIGHT	60'
MAX. LOT COVERAGE	N/A
MAX. IMPERV. COVERAGE	80%
MIN. OPEN SPACE	20%

WAIVERS LIST:

- 1. Ch. 200 §204-3.F.1: Waiver from the requirement to provide a Traffic Impact Assessment.
- 2. Ch. 200 §204-4.B: Waiver from the requirement that site plan be drawn at a scale of one inch equals forty feet.
- 3. Ch. 200 §204-5.C.3: Waiver from the requirement to provide an existing landscape inventory.
- 4. Ch. 200 §207-9.E: Waiver from the requirement to provide a pedestrian walkway.
- 5. Ch. 200 §207-12.B: Waiver from the requirement to provide parking to the side or rear of the site.
- 6. Ch. 200 §207-12.G.3a: Waiver from the requirement that parking spaces should not be within twenty feet of building entrances.
- 7. Ch. 200 §207-12.G.3.b: Waiver from the requirement that parking shall not be located within fifteen feet of the side property line.

CIVIL ENGINEER:

CMG ENVIRONMENTAL, INC. 67 HALL ROAD STURBRIDGE, MA 01560 CONTACT: DAVID FAIST, P.E. (774) 241 - 0901

ARCHITECT:


GROUP 7 DESIGN
70 NORTH ST., SUITE 2B
MEDFIELD, MA 02052
CONTACT: LUANNE PERRY, FRDI, LEED ID+C
(508) 458 - 4545

SURVEYOR:

O'DRISCOLL LAND SURVEYING, INC. 46 COTTAGE ST MEDWAY, MA 02053 CONTACT: DANIEL O'DRISCOLL, P.L.S. (508) 533 - 3314


WETLAND SPECIALIST:

LEC ENVIRONMENTAL CONSULTANTS, INC. 100 GROVE STREET, SUITE 302 WORCESTER, MA 01605 CONTACT: ANDREA KENDALL, PWS (508) 753 - 3077

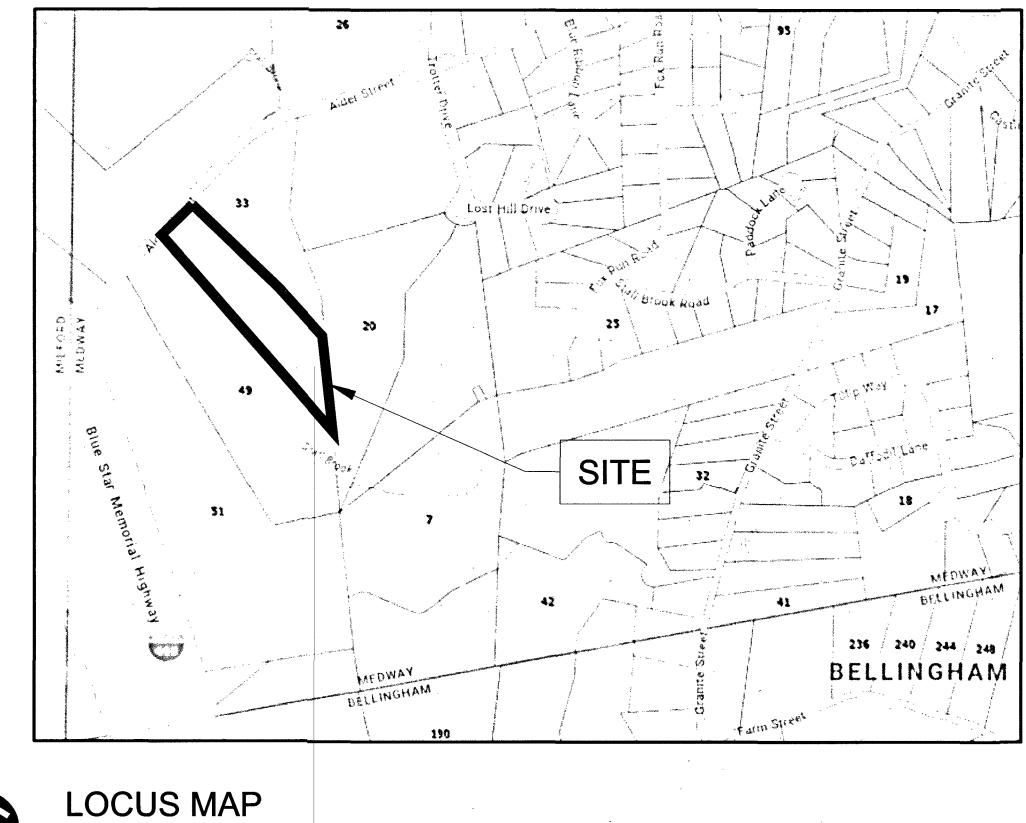

LOCUS MAP	· ·	
APPROXIMATE SCALE: 1" = 500'	•	
STALL ROOK		
PROP. PAVED PARKING AREA		
PROP. PAVED STORAGE AREA PROP. COMMERCIAL 7.400 S.F.		
S. Pat.		
SEE SHEETS		
C-1 THROUGH C-4		

SHEET#	SHEET NAME
T-1.0	TITLE SHEET
N-1.0	GENERAL NOTES SHEET
1 OF 1	EXISTING CONDITIONS PLAN SURVEY (BY O'DRISCOLL LAND SURVEYING, INC.)
C-1.0	SITE LAYOUT PLAN
C-2.0	GRADING & DRAINAGE PLAN
C-3.0	UTILITY PLAN
C-4.0	EROSION & SEDIMENT CONTROL PLAN
C-4.1	EROSION & SEDIMENT CONTROL DETAIL
C-5.0 - C-5.2	CONSTRUCTION DETAILS
1 OF 1	CULTEC STORMWATER CHAMBER DETAILS
C-6.0	FIRE TRUCK TURN TEMPLATE
C-6.1	WB-50 TRUCK TURN TEMPLATE
C-7.0	DUMPSTER STORAGE LOCATION PLAN
L-1.0	PLANTING PLAN (BY JCLA)
L-2.0	PLANTING DETAILS (BY JCLA)
1 OF 1	LIGHTING PLANS (BY OTHERS)
· ·	FLOOR PLAN (BY GROUP 7)
-	FRONT / SIDE ELEVATION (BY GROUP 7)

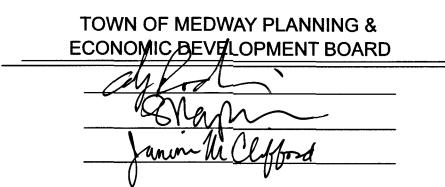

11/11/24

APPROVAL DATE
3/11/25

ENDORSEMENT DATE

I, STEFANY OHANNESIAN, CLERK OF THE TOWN OF MEDWAY, HEREBY CERTIFY THAT TWENTY DAYS HAVE ELAPSED FROM THE DATE OF THE DECISION AND THAT NO APPEAL HAS BEEN FILED ON THIS OFFICE.

. Bran Ohan	
ATTEST: TOWN CLEF	RK

3/24/2025 DATE

NO.	DATE	DESCRIPTION
7.	6/5/2023	REVISED PER CON. COMM. SITE WALK
2.	10/19/2023	PER TOWN & PEER REVIEW COMMENT
3.	3/4/2024	CLIENT CHANGE OF USE/BUILDING
4.	9/4/2024	APPLICANT CHANGE & BUILDING MODIFICATI
5.	11/1/2024	PER TOWN & PEER REVIEW COMMENT
6.	2/26/2025	FINAL PEDB ENDORSEMENT SET
7.	3/11/2025	DRAINAGE EASEMENT MODIFICATION



PROPOSED COMMERCIAL BUILDING
39 ALDER STREET
MEDWAY, MA 02053
49 ALDER STREET
MEDWAY, MA 02053
MEDWAY, MA 02053

ENGINEERING SERVICES
ENVIRONMENTAL SERVICES
67 Hall Road
Sturbridge, MA 01566
Phone: 774-241-0901
fax: 774-241-0906



ISSUE DATE: 4/12/2023

DRAWN BY: MM CHECKED BY: DTF
SCALE: AS NOTED
PROJECT NO.: 2024-128

TITLE SHEET

T-1.0

APPROXIMATE SCALE: 1" = 60'

GENERAL NOTES:

- 1. CONTRACTOR SHALL ADHERE TO AND IS RESPONSIBLE FOR COMPLIANCE WITH ALL DETAILS, NOTES, PLANS AND SPECIFICATIONS CONTAINED HEREIN. IT IS THE RESPONSIBILITY OF THE CONTRACTOR TO ENSURE THAT ALL WORK PERFORMED BY THEIR SUBCONTRACTORS IS IN FULL COMPLIANCE WITH THESE REQUIREMENTS. THE FOLLOWING DOCUMENTS ARE INCORPORATED BY REFERENCE AS PART OF THIS SITE PLAN:
- "EXISTING CONDITIONS PLAN ETS EQUIPMENT RENTAL, INC", PREPARED BY O'DRISCOLL LAND SURVEYING, INC, DATED 4/12/2023.
- "WETLAND RESOURCE AREA ANALYSIS REPORT 39 ALDER STREET, MEDWAY, MA", PREPARED BY LEC ENVIRONMENTAL CONSULTANTS, INC., DATED 12/15/2022.
 ARCHITECTURAL FLOOR PLAN AND ELEVATION PLANS PREPARED FOR LAWRENCE WASTE SERVICES, BY GROUP 7 DESIGN.
- THE CONTRACTOR MUST HAVE COPIES OF ALL PERMITS AND APPROVALS ON SITE AT ALL TIMES. THE CONTRACTOR IS RESPONSIBLE TO ENSURE THAT ALL REQUIRED PERMITS AND APPROVALS HAVE BEEN OBTAINED PRIOR TO PERFORMING ANY WORK ON-SITE OR OFF-SITE. THE CONTRACTOR SHALL THOROUGHLY REVIEW AND UNDERSTAND ALL PERMITS AND PERMIT CONDITIONS, AND NOTIFY THE ENGINEER OF ANY CONFLICT WITH THE DESIGN PLAN PRIOR TO FABRICATION OF ANY MATERIALS OR PRODUCTS TO BE USED AS PART OF THE PROJECT.
- 3. ALL WORK SHALL BE EXECUTED IN ACCORDANCE WITH THESE PLANS, THE PROJECT'S SPECIFICATIONS, CONDITIONS OF APPROVALS AND PERMITS, AND ALL APPLICABLE RULES, REGULATIONS, CODES, LAWS AND STANDARDS OF ALL AUTHORITIES HAVING JURISDICTION OVER THE PROJECT.
- 4. THE GEOTECHNICAL REPORT AND RECOMMENDATIONS NOTED HEREIN ARE A PART OF THE CONSTRUCTION PLANS AND DOCUMENTS. IF DISCREPANCY OR AMBIGUITY EXISTS, THE MORE STRINGENT REQUIREMENTS AND/OR RECOMMENDATIONS CONTAINED IN THE PLANS AND THE GEOTECHNICAL REPORT GOVERN. THE CONTRACTOR SHALL IMMEDIATELY NOTIFY THE ENGINEER IN WRITING SHOULD ANY CONFLICTS BE IDENTIFIED PRIOR TO COMMENCING WITH ANY ADDITIONAL WORK.
- 5. CONTRACTOR SHALL FIELD VERIFY ALL EXISTING CONDITIONS AND PROPOSED LAYOUT DIMENSIONS AND MUST NOTIFY CMG ENVIRONMENTAL, INC. IN WRITING IMMEDIATELY IF ACTUAL SITE CONDITIONS DIFFER OR ARE IN CONFLICT WITH THE PROPOSED WORK. NO COMPENSATION WILL BE PAID TO THE CONTRACTOR FOR ADDITIONAL WORK THAT HA TO BE REDONE OR REPAIRED DUE TO DIMENSIONS OR GRADES SHOWN INCORRECTLY ON THESE PLANS UNLESS THE CONTRACTOR RECEIVES WRITTEN PERMISSION FROM CMG.
- 6. CONTRACTOR SHALL REFER TO THE ARCHITECTURAL/ BUILDING PLANS FOR ALL BUILDING AND ADJACENT APPURTENANCES FOR EXACT LOCATIONS AND DIMENSIONS SUCH AS ENTRY/ EXIT DOOR LOCATIONS, ELEVATIONS, BUILDING DIMENSIONS, AND EXACT UTILITY CONNECTION LOCATIONS.
- 7. PRIOR TO PERFORMING ANY WORK ONSITE, THE CONTRACTOR SHALL REVIEW ALL CONSULTANTS PLANS AND SPECIFICATIONS INCLUDING THE ENTIRE SITE PLAN AND THE LATEST ARCHITECTURAL PLANS (INCLUDING, BUT NOT LIMITED TO, STRUCTURAL, MECHANICAL, ELECTRICAL, PLUMBING, AND FIRE SUPPRESSION PLAN, WHERE APPLICABLE). CONTRACTOR MUST IMMEDIATELY NOTIFY ARCHITECT AND SITE ENGINEER IN WRITING OF ANY CONFLICTS, DISCREPANCIES, OR AMBIGUITIES WHICH EXIST.
- 8. DEBRIS MUST NOT BE BURNED OR BURIED ON SITE AND ALL UNSUITABLE EXCAVATED MATERIAL AND DEBRIS (SOLID WASTE) MUST BE DISPOSED OF IN ACCORDANCE WITH THE PROJECT'S SPECIFICATIONS AND PLANS, AND ALL LOCAL STATE, AND FEDERAL RULES AND REGULATIONS.
- 9. THE CONTRACTOR IS RESPONSIBLE FOR ALL EXCAVATIONS AND THE DESIGN AND INSTALLATION OF ANY SHORING THAT MAY BE REQUIRED, ALL OF WHICH SHALL BE IN ACCORDANCE WITH CURRENT OSHA STANDARDS. THE CONTRACTOR IS ALSO RESPONSIBLE FOR IMPLEMENTING ANY ADDITIONAL PRECAUTIONS TO PROTECT AND ASSURE STABILITY OF ADJACENT, NEARBY AND CONTIGUOUS STRUCTURES AND PROPERTIES.
- 10. THE CONTRACTOR SHALL PROTECT AND ASSURE STABILITY OF STRUCTURES (SIDEWALKS AND PAVEMENT, UTILITIES, BUILDINGS, AND INFRASTRUCTURE) ADJACENT TO THE WORK AREA THAT ARE TO REMAIN, AND IMPLEMENT ANY APPROPRIATE MEASURES REQUIRED TO ENSURE STRUCTURAL STABILITY OF THE SAME. CONTRACTOR SHALL ASSURE A SAFE WORK AREA FOR WORKERS, PEDESTRIANS, ANY THIRD PARTY, AND ABUTTING PROPERTIES.
- 11. THE CONTRACTOR IS RESPONSIBLE FOR ALL "MEANS AND METHODS" NECESSARY TO PREVENT MOVEMENT, SETTLEMENT, OR COLLAPSE OF EXISTING OR PROPOSED STRUCTURES (INCLUDING BUT NOT LIMITED TO DRAINAGE, UTILITIES, PAVEMENT, STRIPING, CURB, ETC.) AND ANY OTHER IMPROVEMENTS THAT ARE TO REMAIN AND SHALL BEAR ANY AND ALL COSTS THAT MAY BE ASSOCIATED WITH THE SAME. IF ANY EXISTING STRUCTURES THAT ARE TO REMAIN ARE DAMAGED DURING DEMOLITIONS, REPAIRS SHALL BE MADE USING NEW PRODUCT/ MATERIALS RESULTING IN A PRE-DEMOLITION CONDITION, OR BETTER. CONTRACTOR IS RESPONSIBLE TO DOCUMENT ALL EXISTING DAMAGE AND NOTIFY THE OWNER AND THE CONSTRUCTION MANAGER PRIOR TO THE START OF
- 12. ALL CONCRETE MUST BE AIR ENTRAINED WITH A MINIMUM COMPRESSIVE STRENGTH OF 4,000 PSI AT 28 DAYS UNLESS OTHERWISE SPECIFIED ON THE PLANS, DETAILS, AND/OR GEOTECHNICAL REPORT
- 13. CMG ENVIRONMENTAL, INC. HAS NO RESPONSIBILITY REGARDING JOB SAFETY AND/OR OVERSIGHT/ SUPERVISION, OR ANYTHING RELATED TO THE SAME, LEGALLY NOR CONTRACTUALLY. AT ANY TIME, CMG ENVIRONMENTAL, INC. IS NOT RESPONSIBLE TO IDENTIFY OR REPORT ANY JOB SAFETY ISSUES.
- 14. CMG ENVIRONMENTAL, INC. WILL REVIEW CONTRACTOR SUBMITTALS WHICH THE CONTRACTOR IS REQUIRED TO SUBMIT, BUT ONLY FOR THE SOLE PURPOSE OF CHECKING FOR CONFORMANCE WITH THE INTENT OF THE DESIGN AND CONTRACT DOCUMENTS. CMG ENVIRONMENTAL, INC. IS NOT RESPONSIBLE FOR ANY DEVIATION FROM THE CONSTRUCTION DOCUMENTS UNLESS CONTRACTOR RECEIVED EXPLICIT DIRECTION TO DO SO, IN WRITING, FROM CMG ENVIRONMENTAL, INC.
- 15. THE CONTRACTOR IS RESPONSIBLE FOR IMPLEMENTING AND MAINTAINING A TRAFFIC PROTECTION PLAN FOR ALL WORK THAT AFFECTS PUBLIC TRAVEL EITHER ON AND/OR OFF-SITE. THE COST ASSOCIATED WITH THE PREPARATION AND IMPLEMENTATION OF SAID PLAN SHALL BE INCLUDED IN THE BASE BID/ CONTRACT COST.
- 16. ALL ONSITE AND OFF-SITE SIGNAGE AND PAVEMENT MARKINGS SHALL CONFORM TO MANUAL IF UNIFORM CONTROL DEVICES OR LOCAL APPROVAL REQUIREMENTS.
- 17. THE CONTRACTOR SHALL INSTALL AND/OR CONSTRUCT ALL ASPECTS OF THE PROJECT IN STRICT COMPLIANCE WITH AND ACCORDANCE WITH MANUFACTURER'S INSTALLATION STANDARDS, RECOMMENDATIONS AND SPECIFICATIONS, AND IN CASE OF CONFLICT, THE MORE RESTRICTIVE SHALL GOVERN.

GENERAL DEMOLITION NOTES:

- 1. THE DEMOLITION PLAN IS INTENDED TO PROVIDE ONLY GENERAL INFORMATION REGARDING ITEMS TO BE DEMOLISHED AND/OR REMOVED.
- 2. THIS PLAN REFERENCES MATERIALS AND DOCUMENTS NOTED HEREIN, IN PARTICULAR BUT NOT LIMITED TO THOSE LISTED IN THE GENERAL NOTES SECTION.
- 3. CONTRACTOR MUST NOTIFY, IN WRITING, CMG ENVIRONMENTAL, INC., IF THEY HAVE ANY QUESTIONS CONCERNING THE ACCURACY OR INTENT OF THESE PLANS, RELATED SPECIFICATIONS, ANY APPLICABLE SAFETY STANDARDS, OR THE SAFETY OF THE CONTRACTOR OR THIRD PARTIES IN PERFORMING THE WORK ON THIS PROJECT. IF SUCH NOTIFICATION IS GIVEN, NO DEMOLITION OR SITE ACTIVITY MAY BEGIN UNTIL SUCH TIME THAT CMG ENVIRONMENTAL, INC. PROVIDES A WRITTEN RESPONSE TO SAME. ALL DEMOLITION WORK MUST BE PERFORMED IN ACCORDANCE WITH THESE PLANS, THE PROJECT SPECIFICATIONS AND ALL APPLICABLE LOCAL, STATE, AND FEDERAL REGULATIONS.
- 4. CONTRACTOR SHALL PERFORM ALL WORK IN A SYSTEMATIC AND SAFE MANNER AND IN ACCORDANCE WITH THE REQUIREMENTS OF THE OCCUPATIONAL SAFETY AND HEALTH ACT OF 1970, (29 U.S.C. 651 ET SEQ.), AMENDMENTS TO AND/OR REVISIONS TO SAME.
- 5. PRIOR TO STARTING ANY SITE ACTIVITY OR DEMOLITION, THE CONTRACTOR SHALL OBTAIN ALL REQUIRED PERMITS (LOCAL, STATE, AND/OR FEDERAL) AND MAINTAIN SAME ON SITE FOR REVIEW BY THE ENGINEER AND OTHER REGULATORY AGENCIES THROUGHOUT THE DURATION OF THE PROJECT.
- 6. PRIOR TO STARTING ANY SITE ACTIVITY OR DEMOLITION, THE CONTRACTOR SHALL NOTIFY, AT A MINIMUM, THE BUILDING OFFICIAL, CITY ENGINEER, DEPARTMENT OF PUBLIC WORKS, PLANNING AND/OR ZONING COMMISSIONS/BOARDS, THE DESIGN ENGINEER, AND LOCAL WETLAND COMMISSION, 72 HOURS PRIOR TO THE START OF WORK.
- 7. PRIOR TO STARTING ANY SITE ACTIVITY OR DEMOLITION, THE CONTRACTOR SHALL IMPLEMENT THE SOIL EROSION AND SEDIMENT CONTROL MEASURES AS NOTED ON THE PLANS AND PRIOR TO ANY SITE DISTURBANCE.
- 8. PRIOR TO STARTING ANY SITE ACTIVITY OR DEMOLITION, THE CONTRACTOR SHALL "CALL BEFORE YOU DIG" AND/OR THE APPLICABLE STATE DAMAGE CONTROL SYSTEM FOR THE REQUIRED UTILITY MARK OUTS IN ADVANCE OF ANY EARTH DISTURBANCE. IN ADDITION TO THIS, THE CONTRACTOR SHALL BE RESPONSIBLE FOR LOCATING AL EXISTING ONSITE UTILITIES INCLUDING BUT NOT LIMITED TO GAS, WATER, ELECTRIC, SANITARY, AND STORM SEWER, TELEPHONE, CABLE, FIBER OPTIC CABLE, ETC. WITHIN AND ADJACENT TO THE LIMITS OF THE WORK.
- 9. PRIOR TO CONSTRUCTION, THE CONTRACTOR SHALL SECURE THE SITE AS NECESSARY TO PERFORM THE DEMOLITION IN A MANNER AS TO PREVENT THE ENTRY OF UNAUTHORIZED
- 10. THE CONTRACTOR SHALL PROTECT AND MAINTAIN THE OPERATION AND SERVICE OF ALL ACTIVE UTILITIES AND SYSTEMS THAT ARE NOT BEING REMOVED DURING ALL DEMOLITION ACTIVITIES. SHOULD A TEMPORARY INTERRUPTION OF UTILITY SEVRICES BE REQUIRED AS PART OF THE PROPOSED CONSTRUCTION ACTIVITIES, THE CONTRACTOR SHALL COORDINATE WITH APPROPRIATE UTILITY COMPANIES AND THE AFFECTED END USER TO MINIMIZE IMPACT AND SERVICE INTERRUPTION.
- 11. THE CONTRACTOR SHALL ARRANGE FOR AND COORDINATE WITH THE APPROPRIATE UTILITY COMPANIES FOR THE TEMPORARY AND PERMANENT TERMINATION OF ANY AND ALL SERVICES THAT ARE REQUIRED FOR THE PROPERTY WHETHER SHOWN ON THE SITE PLANS OR NOT. TERMINATION OF UTILITIES SHALL BE PERFORMED IN COMPLIANCE WITH ALL LOCAL, STATE, AND/OR FEDERAL REGULATIONS.
- 12. SHOULD HAZARDOUS MATERIAL BE DISCOVERED/ ENCOUNTERED, WHICH WAS NOT ANTICIPATED AND/OR ADDRESSED IN THE PROJECT PLANS AND SPECIFICATIONS, CEASE ALL WORK IMMEDIATELY AND NOTIFY OWNER AND ENGINEER OF RECORD REGARDING THE DISCOVERY OF SAME.
- 13. CMG ENVIRONMENTAL, INC. HAS NO RESPONSIBILITY REGARDING JOB SAFETY AND/OR OVERSIGHT AND SUPERVISION, OR ANYTHING RELATED TO SAME, LEGALLY NOR CONTRACTUALLY.
- 14. THE CONTRACTOR IS RESPONSIBLE FOR ALL "MEANS AND METHODS" NECESSARY TO PREVENT MOVEMENT, SETTLEMENT, OR COLLAPSE OF EXISTING STRUCTURES, AND ANY OTHER IMPROVEMENTS THAT ARE TO REMAIN. IF ANY EXISTING STRUCTURES THAT ARE TO REMAIN ARE DAMAGED DURING DEMOLITION, REPAIRS SHALL BE MADE USING NEW PRODUCT/ MATERIALS RESULTING IN A PRE-DEMOLITION CONDITION, OR BETTER. CONTRACTOR IS RESPONSIBLE FOR ALL REPAIR COSTS.
- 15. ALL BACKFILLING REQUIRED AS A RESULT OF DEMOLITION SHALL BE PERFORMED IN COMPLIANCE WITH THE RECOMMENDATIONS AND GUIDANCE OF THE OF THE GEOTECHNICAL REPORT, OR IN ITS ABSENCE, THE STANDARD STATE DOT SPECIFICATIONS FOR ROADWAY CONSTRUCTION (LATEST EDITION).
- 16. THE USE OF EXPLOSIVES FOR THE PURPOSE OF DEMOLITION OR ROCK REMOVAL MUST BE IN COMPLIANCE OF ALL LOCAL, STATE, AND FEDERAL REGULATIONS. THE CONTRACTOR SHALL OBTAIN ALL PERMITS THAT ARE REQUIRED BY THE FEDERAL, STATE, AND FEDERAL REGULATIONS. THE CONTRACTOR IS ALSO RESPONSIBLE FOR ALL INSPECTIONS, MONITORING, OR TESTING AS MAY BE REQUIRED BY ANY AND ALL PERMITS AND REGULATIONS.
- 17. CONTRACTOR SHALL CONTROL TRAFFIC ON AND OFFSITE IN CONFORMANCE WITH THE CURRENT FHWA "MANUAL ON UNIFORM TRAFFIC CONTROL DEVICES" (MUTCD), AND THE FEDERAL, STATE, AND LOCAL REGULATIONS FOR ALL ASPECTS OF DEMOLITION AND SITE
- 18. CMG ENVIRONMENTAL, INC. IS NOT RESPONSIBLE FOR THE MEANS, METHOD, AND/OR PROCEDURES TO BE IMPLEMENTED FOR THE PROJECT. ALL WORK MUST BE IN STRICT ACCORDANCE WITH ALL STATE, FEDERAL, LOCAL, AND JURISDICTIONAL REQUIREMENTS.
- 19. DEBRIS SHALL NOT BE BURIED ON SITE. ALL DEMOLITION MATERIALS TO BE DISPOSED OF SHALL BE DONE SO IN ACCORDANCE WITH ALL MUNICIPAL, COUNTY, STATE, AND FEDERAL LAWS AND APPLICABLE CODES. THE CONTRACTOR MUST MAINTAIN RECORDS OF ALL DISPOSAL AND TRANSPORT ACTIVITIES INCLUDING DEBRIS AND SOIL REMOVAL.
- 20. CONTRACTOR MUST PREPARE RECORD DRAWINGS OF ALL SUBTERRANEAN UTILITIES PRIOR TO BURIAL DEPICTING THE LOCATION OF EXISTING UTILITIES THAT ARE CAPPED, ABANDONED IN PLACE, OR RELOCATED AS WELL AS NEW UTILITY SERVICES AND PROVIDE TO THE PROPERTY OWNER AND THE ENGINEER OF RECORD.

TYPICAL ABBREVIATIONS					
PROP.	PROPOSED	E.O.P.	EDGE OF PAVEMENT	VAC.	VACUUM
EX.	EXISTING	V.G.C.	VERTICAL GRANITE CURB	TRANS.	TRANFORMER
N/F	NOW OR FORMERLY	S.G.C.	SLOPED GRANITE CURB	GEN.	GENERATOR
ND	NOT DETERMINED	C.C.B.	CAPE COD BERM	APPROX. LOC.	APPROXIMATE LOCATION
TBR	TO BE REMOVED	B.C.C.	BITUMINOUS CONCRETE CURB	INV.	INVERT
CONC.	CONCRETE	C.C.	CONCRETE CURB	TBD	TO BE DETERMINED
BIT.	BITUMINOUS	W.G.	WATER GATE	FF	FINISH FLOOR ELEVATION
UP	UTILITY POLE	G.G.	GAS GATE	TF	TOP OF FOUNDATION ELEVATION
L.S.A.	LANDSCAPE AREA	M.E.	MATCH EXISTING	OHD	OVERHEAD DOOR

GENERAL GRADING & UTILITY NOTES:

- PRIOR TO STARTING ANY SITE ACTIVITY OR DEMOLITION, THE CONTRACTOR SHALL "CALL BEFORE YOU DIG", "DIG SAFE" AND/OR APPLICABLE STATE DAMAGE CONTROL SYSTEM FOR THE REQUIRED UTILITY MARK OUTS IN ADVANCE OF ANY EARTH DISTURBANCE. IN ADDITION TO THIS, THE CONTRACTOR SHALL BE RESPONSIBLE FOR LOCATING ALL EXISTING ONSITE UTILITIES INCLUDING BUT NOT LIMITED TO GAS, WATER, ELECTRIC, SANITARY AND STORM SEWER, TELEPHONE, CABLE, FIBER OPTIC CABLE, ETC. WITHIN AND ADJACENT TO THE LIMITS OF THE PROJECT ACTIVITIES. LOCATIONS OF ALL EXISTING AND PROPOSED SERVICES ARE APPROXIMATE AND MUST BE INDEPENDENTLY CONFIRMED WITH LOCAL UTILITY COMPANIES AND THE CONTRACTOR. WATER, SANITARY SEWER, AND ALL OTHER UTILITY SERVICE CONNECTION POINTS MUST BE INDEPENDENTLY CONFIRMED BY THE CONTRACTOR IN THE FIELD PRIOR TO THE COMMENCEMENT OF CONSTRUCTION. ALL DISCREPANCIES MUST IMMEDIATELY BE REPORTED IMMEDIATELY IN WRITING TO THE ENGINEER.
- 2. CONSTRUCTION SHALL BEGIN AT THE LOWEST ELEVATION AND/OR INVERT (POINT OF CONNECTION) AND PROGRESS UPGRADIENT. WHERE UTILITIES ARE PROPOSED TO CROSS/TRAVERSE EXISTING UNDERGROUND UTILITIES, THE ELEVATIONS OF THE EXISTING UTILITIES SHALL BE VERIFIED IN THE FIELD PRIOR TO CONSTRUCTION BY EXCAVATING A TEST PIT AT THE PROPOSED UTILITY CROSSING POINT TO VERIFY EXISTING UTILITY LOCATIONS, ELEVATIONS, AND/OR INVERTS. SHOULD THE FIELD VERIFIED EXISTING UTILITY BE IN CONFLICT WITH THE PROPOSED SITE DESIGNS, THE CONTRACTOR SHALL NOTIFY THE DESIGN ENGINEER IN WRITING AND SHALL NOT PROCEED WITH SAID UTILITY CONSTRUCTION UNTIL FURTHER DIRECTION IS GIVEN FROM THE DESIGN ENGINEER.
- 3. THE CONTRACTOR IS RESPONSIBLE FOR REPAIRING ALL DAMAGE TO ANY EXISTING UTILITIES DURING CONSTRUCTION, AT NO COST TO THE OWNER. CONTRACTOR SHALL BEAR ALL COSTS ASSOCIATED WITH DAMAGE TO ANY EXISTING UTILITIES DURING CONSTRUCTION.
- 4. THE CONTRACTOR IS RESPONSIBLE FOR REVIEWING ALL CONSTRUCTION AND CONTRACT DOCUMENTS INCLUDING, BUT NOT LIMITED TO, ALL OF THE PERMITS AND CONDITIONS, DRAWINGS, REPORTS AND SPECIFICATIONS ASSOCIATED WITH THE PROJECT PRIOR TO MOBILIZATION FOR AND COMMENCEMENT OF CONSTRUCTION. SHOULD THERE BE ANY CONFLICT AND/OR DISCREPANCY BETWEEN ANY OF THE DOCUMENTS, IT IS THE CONTRACTOR'S RESPONSIBILITY TO NOTIFY THE DESIGN ENGINEER IN WRITING OUTLINING SAID CONFLICT AND/OR DISCREPANCY PRIOR TO THE START OF CONSTRUCTION.
- 5. THE CONTRACTOR MUST INSTALL ALL UTILITIES THAT FUNCTION BY GRAVITY, INCLUDING STORM SEWER AND SANITARY SEWER COMPONENTS, PRIOR TO THE INSTALLATION OF ALL OTHER UTILITIES.
- 6. CONTRACTOR SHALL REFER TO THE ARCHITECTURAL DESIGN FOR EXACT BUILDING UTILITY CONNECTION LOCATIONS AND SERVICE SIZES, GREASE TRAP REQUIREMENTS/DETAILS, DOOR ACCESS, AND EXTERIOR GRADING AND REPORT CONFLICT WITH THE SITE PLAN TO THE ENGINEER.
- 7. THE CONTRACTOR MUST COORDINATE INSTALLATION OF ALL UTILITY'S SERVICES WITH THE INDIVIDUAL SERVICE PROVIDER TO ASSURE INDIVIDUAL INSTALLATION REQUIREMENTS ARE MET. THE CONTRACTOR SHALL ENSURE THAT INSTALLATION OF ALL IMPROVEMENTS COMPLIES WITH ALL UTILITY REQUIREMENTS SET FORTH BY THE JURISDICTION HAVING AUTHORITY AND CONTROL OF SAID UTILITY.
- 8. WATER SERVICE AND WATER MAIN INSTALLATIONS SHALL BE PER THE SPECIFICATIONS OF THE LOCAL UTILITY COMPANY HAVING JURISDICTION OF THE UTILITY INCLUDING, BUT NOT LIMITED TO PRODUCT MATERIALS AND BURIAL DEPTHS. CONTRACTOR SHALL COORDINATE WITH THE WATER UTILITY COMPANY AND THE ARCHITECT TO ASSURE PROPER WATER METER SIZING PRIOR TO CONSTRUCTION.
- 9. SERVICES FOR ELECTRICAL, CABLE TV, FIBER OPTIC, TELEPHONE, ETC. SHALL BE INSTALLED UNDERGROUND UNLESS OTHERWISE NOTED ON THE PLANS AND INSTALLED IN ACCORDANCE WITH THE UTILITY SERVICE PROVIDER'S SPECIFICATIONS AND STANDARDS.
- 10. SITE GRADING, EXCAVATION, FILL, COMPACTION AND MATERIALS USED FOR EARTH WORK AND UTILITY INSTALLATIONS SHALL BE PERFORMED IN ACCORDANCE WITH THESE PLANS, SPECIFICATIONS AND THE REQUIREMENTS SET FORTH IN GEOTECHNICAL REPORT REFERENCED FOR THIS PROJECT OR THE APPROPRIATE UTILITY COMPANY'S SPECIFICATIONS, WHEN GEOTECHNICAL REPORT OR RECOMMENDATIONS HAVE NOT BEEN DEVELOPED, ALL SOILS/ MATERIALS, FILLS, AND COMPACTION SHALL COMPLY WITH THE STANDARD STATE DOT SPECIFICATIONS FOR ROADWAY CONSTRUCTION (LATEST EDITION) AND ANY AMENDMENTS OR REVISIONS THERETO. CMG ENVIRONMENTAL, INC. SHALL HAVE NO LIABILITY OR RESPONSIBILITY FOR OR AS RELATED TO FILL, COMPACTION, AND BACKFILL
- 11. THE CONTRACTOR SHALL COMPLY WITH THE LATEST OSHA STANDARD AND REGULATIONS, AS WELL AS ANY LOCAL AUTHORITY THAT MAY HAVE JURISDICTION OVER TRENCHING PROCEDURES. CMG ENVIRONMENTAL, INC. IS NOT RESPONSIBLE FOR ANY MEANS AND METHODS OR PERFORMANCE CRITERIA ASSOCIATED WITH EXCAVATION TRENCHING AND IT IS THE SOLE RESPONSIBILITY OF THE CONTRACTOR APPROPRIATE PROCEDURES ARE
- 12. CONTRACTOR SHALL ADJUST FRAMES, COVERS, AND GRATES OF ALL EXISTING MANHOLES, INLET STRUCTURES, WATER GATE BOXES, AND SANITARY CLEANOUT RISERS AS NECESSARY, TO MATCH PROPOSED GRADES.
- 13. STORM SEWER PIPE SHALL BE REINFORCED CONCRETE PIPE (RCP) CLASS III WITH SILT TIGHT JOINTS. IF HIGH DENSITY POLYETHYLENE PIPE (HDPE) IS SPECIFIED ON THE PLANS, IT MUST CONFORM TO AASHTO M294 AND TYPE S (SMOOTH INTERIOR WITH ANGULAR CORRUGATIONS) WITH GASKET FOR SILT TIGHT JOINT. ROOF DRAINS MUST BE PVC SDR 26 OR SCHEDULE 40 UNLESS INDICATED OTHERWISE.
- 14. SANITARY SEWER PIPE SHALL BE POLYVINYL CHLORIDE (PVC) SDR 35 EXCEPT WHERE INDICATED OTHERWISE. SANITARY SEWER LATERAL MUST BE PVC SCHEDULE 40 OR PVC SDR 26 UNLESS INDICATED, IN WRITING, OTHERWISE.
- 15. PIPE LENGTHS INDICATED FOR SANITARY AND STORM SEWERS ARE MEASURED CENTER OF STRUCTURE TO CENTER OF STRUCTURE.
- 16. ROOF DRAIN LOCATIONS ARE APPROXIMATE; IT IS THE CONTRACTOR'S RESPONSIBILITY FOR COORDINATING THE RROF CONNECTIONS WITH FINAL ARCHITECTURAL PLAN LOCATIONS.
- 17. WATER MAIN AND WATER SERVICE PIPING SHALL BE INSTALLED PER THE LOCAL WATER COMPANY'S OR THE AUTHORITY HAVING JURISDICTION SPECIFICATIONS. IN THE ABSENCE OF SUCH SPECIFICATIONS, WATER MAIN PIPING MUST BE CEMENT-LINED DUCTILE IRON (DIP) MINIMUM CLASS 52 THICKNESS MUST COMPLY WITH THE APPLICABLE AWWA STANDARDS IN EFFECT AT THE TIME OF CONSTRUCTION.
- 18. THE CONTRACTOR SHALL ENSURE THAT ANY AND ALL WORK LOCATED IN THE EXISTING PAVED ROADWAYS AND/OR STREETS BE REPAIRED IN ACCORDANCE WITH THE REFERENCED MUNICIPAL, COUNTY, AND/OR DOT DETAILS AS APPLICABLE. CONTRACTOR IS RESPONSIBLE TO COORDINATE THE PERMITTING, INSPECTION, AND APPROVAL OF COMPLETED WORK WITH THE AGENCY HAVING JURISDICTION OVER THE PROPOSED WORK
- 19. THE RELOCATION OF EXISTING AND/OR THE INSTALLATION OF NEW UTILITY POLES AND TRANSFORMERS ARE AT THE SOLE DISCRETION OF UTILITY COMPANIES TO FINALIZE ALL UTILITY SERVICES AND/OR RELOCATIONS TO ASSURE NO CONFLICT WITH THE DESIGN PLANS. SHOULD A CONFLICT ARISE DUE TO THE FINAL DESIGNS OF THE UTILITY COMPANY, THE CONTRACTOR SHALL NOTIFY THE DESIGN ENGINEER IN WRITING AND AWAIT A WRITTEN RESOLUTION PRIOR TO PROCEEDING WITH FURTHER UTILITY INSTALLATIONS.
- 20. APPLICANT HAS AGREED TO PROVIDE THE TOWN OF MEDWAY WITH A MODIFIED DRAINAGE EASEMENT FOR THE EXISTING TOWN STORMWATER SYSTEM ALONG THE ALDER STREET FRONTAGE. APPLICANT IS RESPONSIBLE FOR PROVIDING A RECORDABLE PLAN SHOWING THE MODIFIED DRAINAGE EASEMENT AS SHOWN ON SHEET C-1.0 AND C-2.0. PURPOSE OF THE EASEMENT WILL BE SOLELY FOR THE ON-GOING AND FUTURE MAINTENANCE OF THE TOWN'S EXISTING STORMWATER DRAIN PIPE AND STORMWATER BASIN LOCATED ON THE 39 ALDER STREET PROPERTY.

ADA INSTRUCTIONS TO CONTRACTORS

- THE CONTRACTOR SHALL REVIEW THE PROPOSED CONSTRUCTION WITH THE LOCAL BUILDING OFFICIAL PRIOR TO THE START OF CONSTRUCTION.
- 2. CONTRACTORS SHALL BE PRECISE IN THE CONSTRUCTION OF AMERICANS WITH DISABILITIES ACT (ADA) ACCESSIBLE PARKING, COMPONENTS, AND ACCESS ROUTES FOR THE PROJECT. THESE COMPONENTS SHALL COMPLY WITH ALL APPLICABLE STATE AND LOCAL ACCESSIBILITY LAWS AND REGULATIONS AND THE CURRENT ADA REGULATIONS AND CONSTRUCTION STANDARDS. THESE COMPONENTS INCLUDE, BUT ARE NOT LIMITED TO THE FOLLOWING:
 - PARKING SPACES AND PARKING AISLES SHALL NOT EXCEED A 1:50 (1/4" PER FOOT OR NOMINALLY 2.0%) SLOPE IN ANY DIRECTION

· CURB RAMPS SHALL NOT EXCEED A 1:12 (8.3%) SLOPE FOR A MAXIMUM LENGTH OF SIX (6) FEET

RAMPS SHALL BE EQUIPPED WITH LANDINGS AT EACH END, SHALL NOT EXCEED 1:50 (2.0%) IN ANY DIRECTION, AND HAVE POSITIVE DRAINAGE AWAY FROM THE LANDING.

· ACCESSIBLE ROUTES SHALL BE A MINIMUM OF 36" WIDE (UNOBSTRUCTED).
HANDRAILS AND CAR OVERHANGS MAY NOT OBSTRUCT THESE AREAS.
LONGITUDINAL SLOPES (DIRECTION OF TRAVEL) SHALL NOT EXCEED 1:20 (5.0%)
AND SHALL HAVE A CROSS SLOPE NO GREATER THAN 1:50 (2.0%)

ACCESSIBLE ROUTES EXCEEDING 1:20 (5.0%) SHALL BE CONSIDERED A "RAMP". MAXIMUM SLOPES OF A RAMP SHALL BE 1:12 (8.3%) IN THE DIRECTION OF TRAVEL, AND A CROSS SLOPE OF 1:50 (2.0%). RAMPS SHALL HAVE MAXIMUM RISE OF 2.5 FEET, SHALL BE EQUIPPED WITH HAND RAILS AND LANDINGS AT THE TOPS AND BOTTOM OF THE RAMP. LANDINGS SHALL NOT EXCEED 1:50 (2.0%) IN ANY DIRECTION AND HAVE POSITIVE DRAINAGE AWAY FOR THE LANDING.

· A LANDING SHALL BE PROVIDED AT THE EXTERIOR OF ALL DOORS. LANDINGS SHALL NOT EXCEED 1:50 (2.0%) IN ANY DIRECTION AND HAVE POSITIVE DRAINAGE AWAY FOR THE LANDING. THE LANDING SHALL BE NO LESS THAN 60 INCHES LONG UNLESS PERMITTED OTHERWISE PER THE ADA REGULATIONS.

3. THE CONTRACTOR SHALL VERIFY ALL EXISTING ELEVATIONS SHOWN ON THE PLAN IN AREAS OF EXISTING DOORWAYS, ACCESSIBLE ROUTES OR OTHER AREAS WHERE RE-CONSTRUCTION IS PROPOSED. THE CONTRACTOR SHALL NOTIFY THE DESIGN ENGINEER OF ANY FIELD CONDITIONS THAT DIFFER IN ANY MANNER FROM WHAT IS SHOWN ON THE PLANS, IN WRITING, BEFORE COMMENCEMENT OF WORK

PROPERTY LINE ABUTTING PROPERTY LINE IRON PIPE MONUMENT UTILITY POLE FIRE HYDRANT W.G. WATER GATE W.G. WATER LINE CATCH BASIN DRAINAGE MAINHOLE DRAINAGE LINE SEWER LINE SEWER LINE OVERHEAD ELECTRIC OHW OVERHEAD ELECTRIC UNDERGROUND ELECTRIC UNDERGROUND ELECTRIC UNDERGROUND ELECTRIC TREELINE SOIL TEST PIT PERCOLATION TEST FENCE TREELINE BOLLARD O BOLLARD EDGE OF WETLANDS WETLAND SYMBOL		LEGEND	
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WETLAND BUFFER		WETLAND BUFFER	
EROSION CONTROL BARRIER		EROSION CONTROL BARRIER	
CATCH BASIN PROTECTION		CATCH BASIN PROTECTION	0

NO.	DATE	DESCRIPTION	ВУ	CK'D
-	6/5/2023	REVISED PER CON. COMM. SITE WALK	RL	DTF
2.	10/19/2023	PER TOWN & PEER REVIEW COMMENTS	MM	DTF
3.	3/4/2024	CLIENT CHANGE OF USE/BUILDING	MM	DTF
4.	9/4/2024	APPLICANT CHANGE & BUILDING MODIFICATION	MM	DTF
5.	11/1/2024	PER TOWN & PEER REVIEW COMMENTS	MM	DTF
6.	2/26/2025	FINAL PEDB ENDORSEMENT SET	MM	DTF
7.	3/11/2025	DRAINAGE EASEMENT MODIFICATION	MM	DTF



PROPOSED COMMERCIAL BUILDI 39 ALDER STREET MEDWAY, MA 02053 EAST HILL ASSOCIATES LLC 49 ALDER STREET

SERVICES
L SERVICES
Road
PREPAR

ENGINEERING SERVICE ENVIRONMENTAL SERVIC 67 Hall Road Sturbridge, MA 01566 Phone: 774-241-090 fax: 774-241-0906



ISSUE DATE: 4/12/2023

DRAWN BY: MM CHECKED BY: DT


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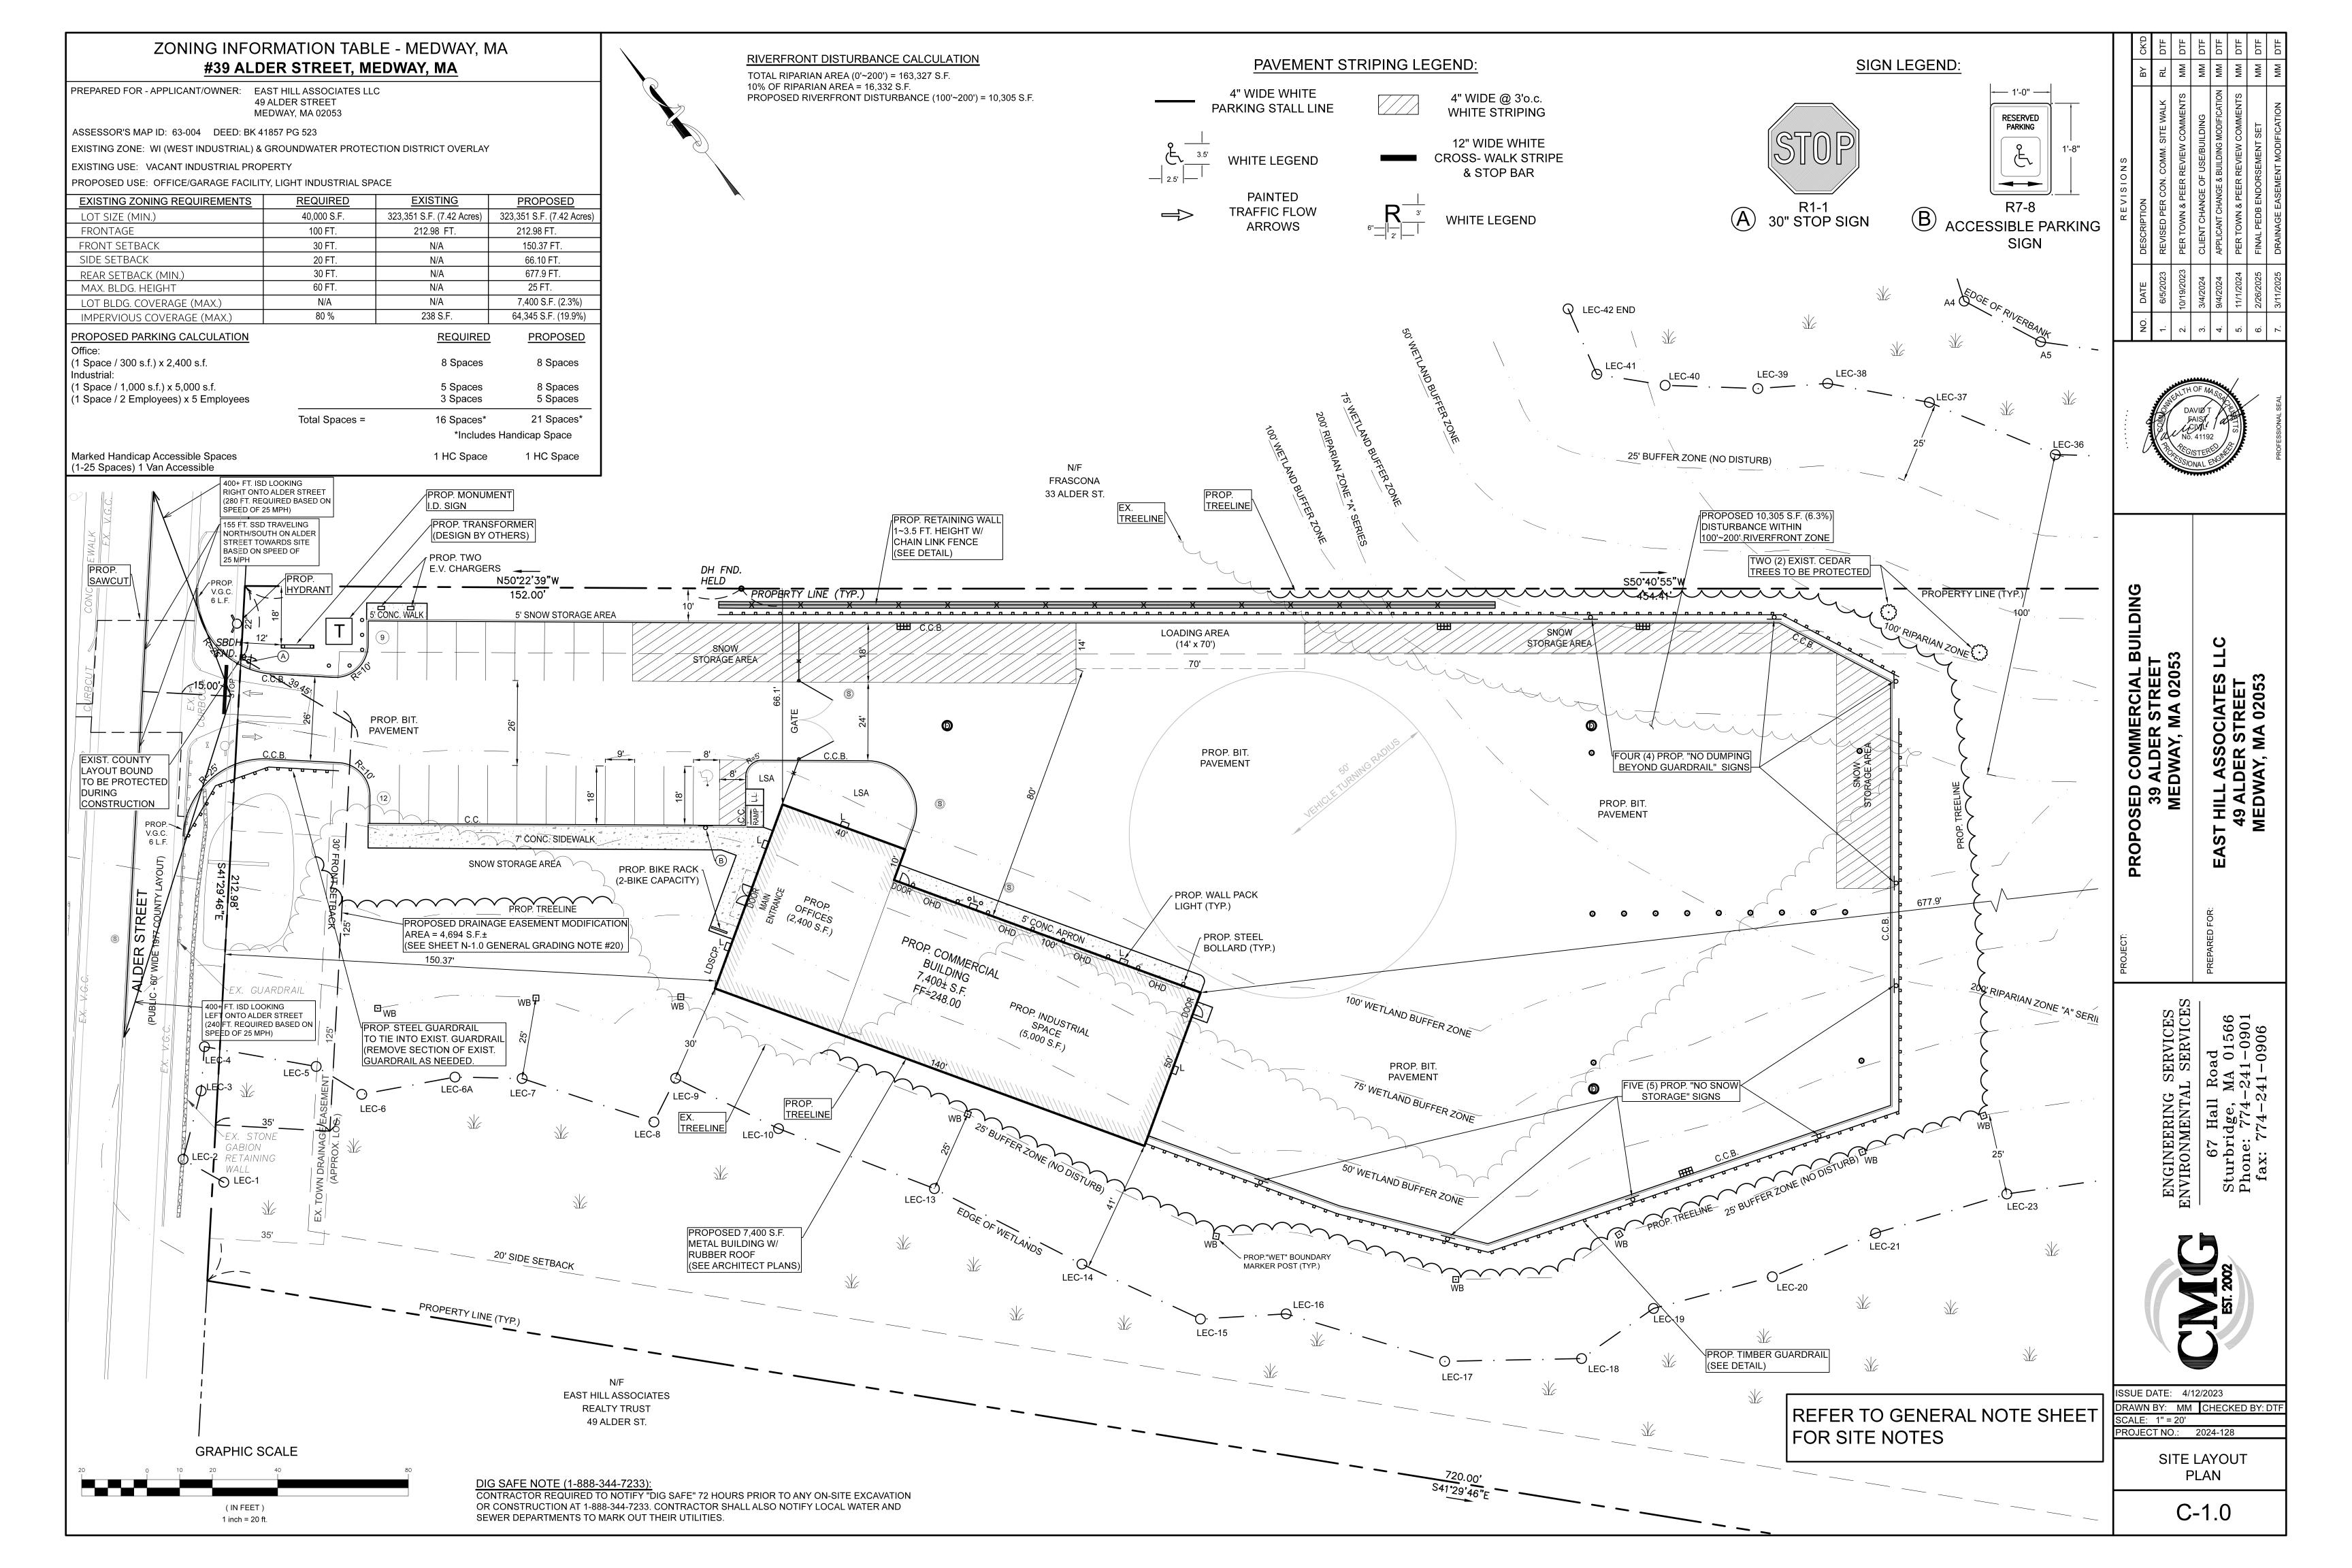
PROJECT NO.: 2024-128


GENERAL NOTES


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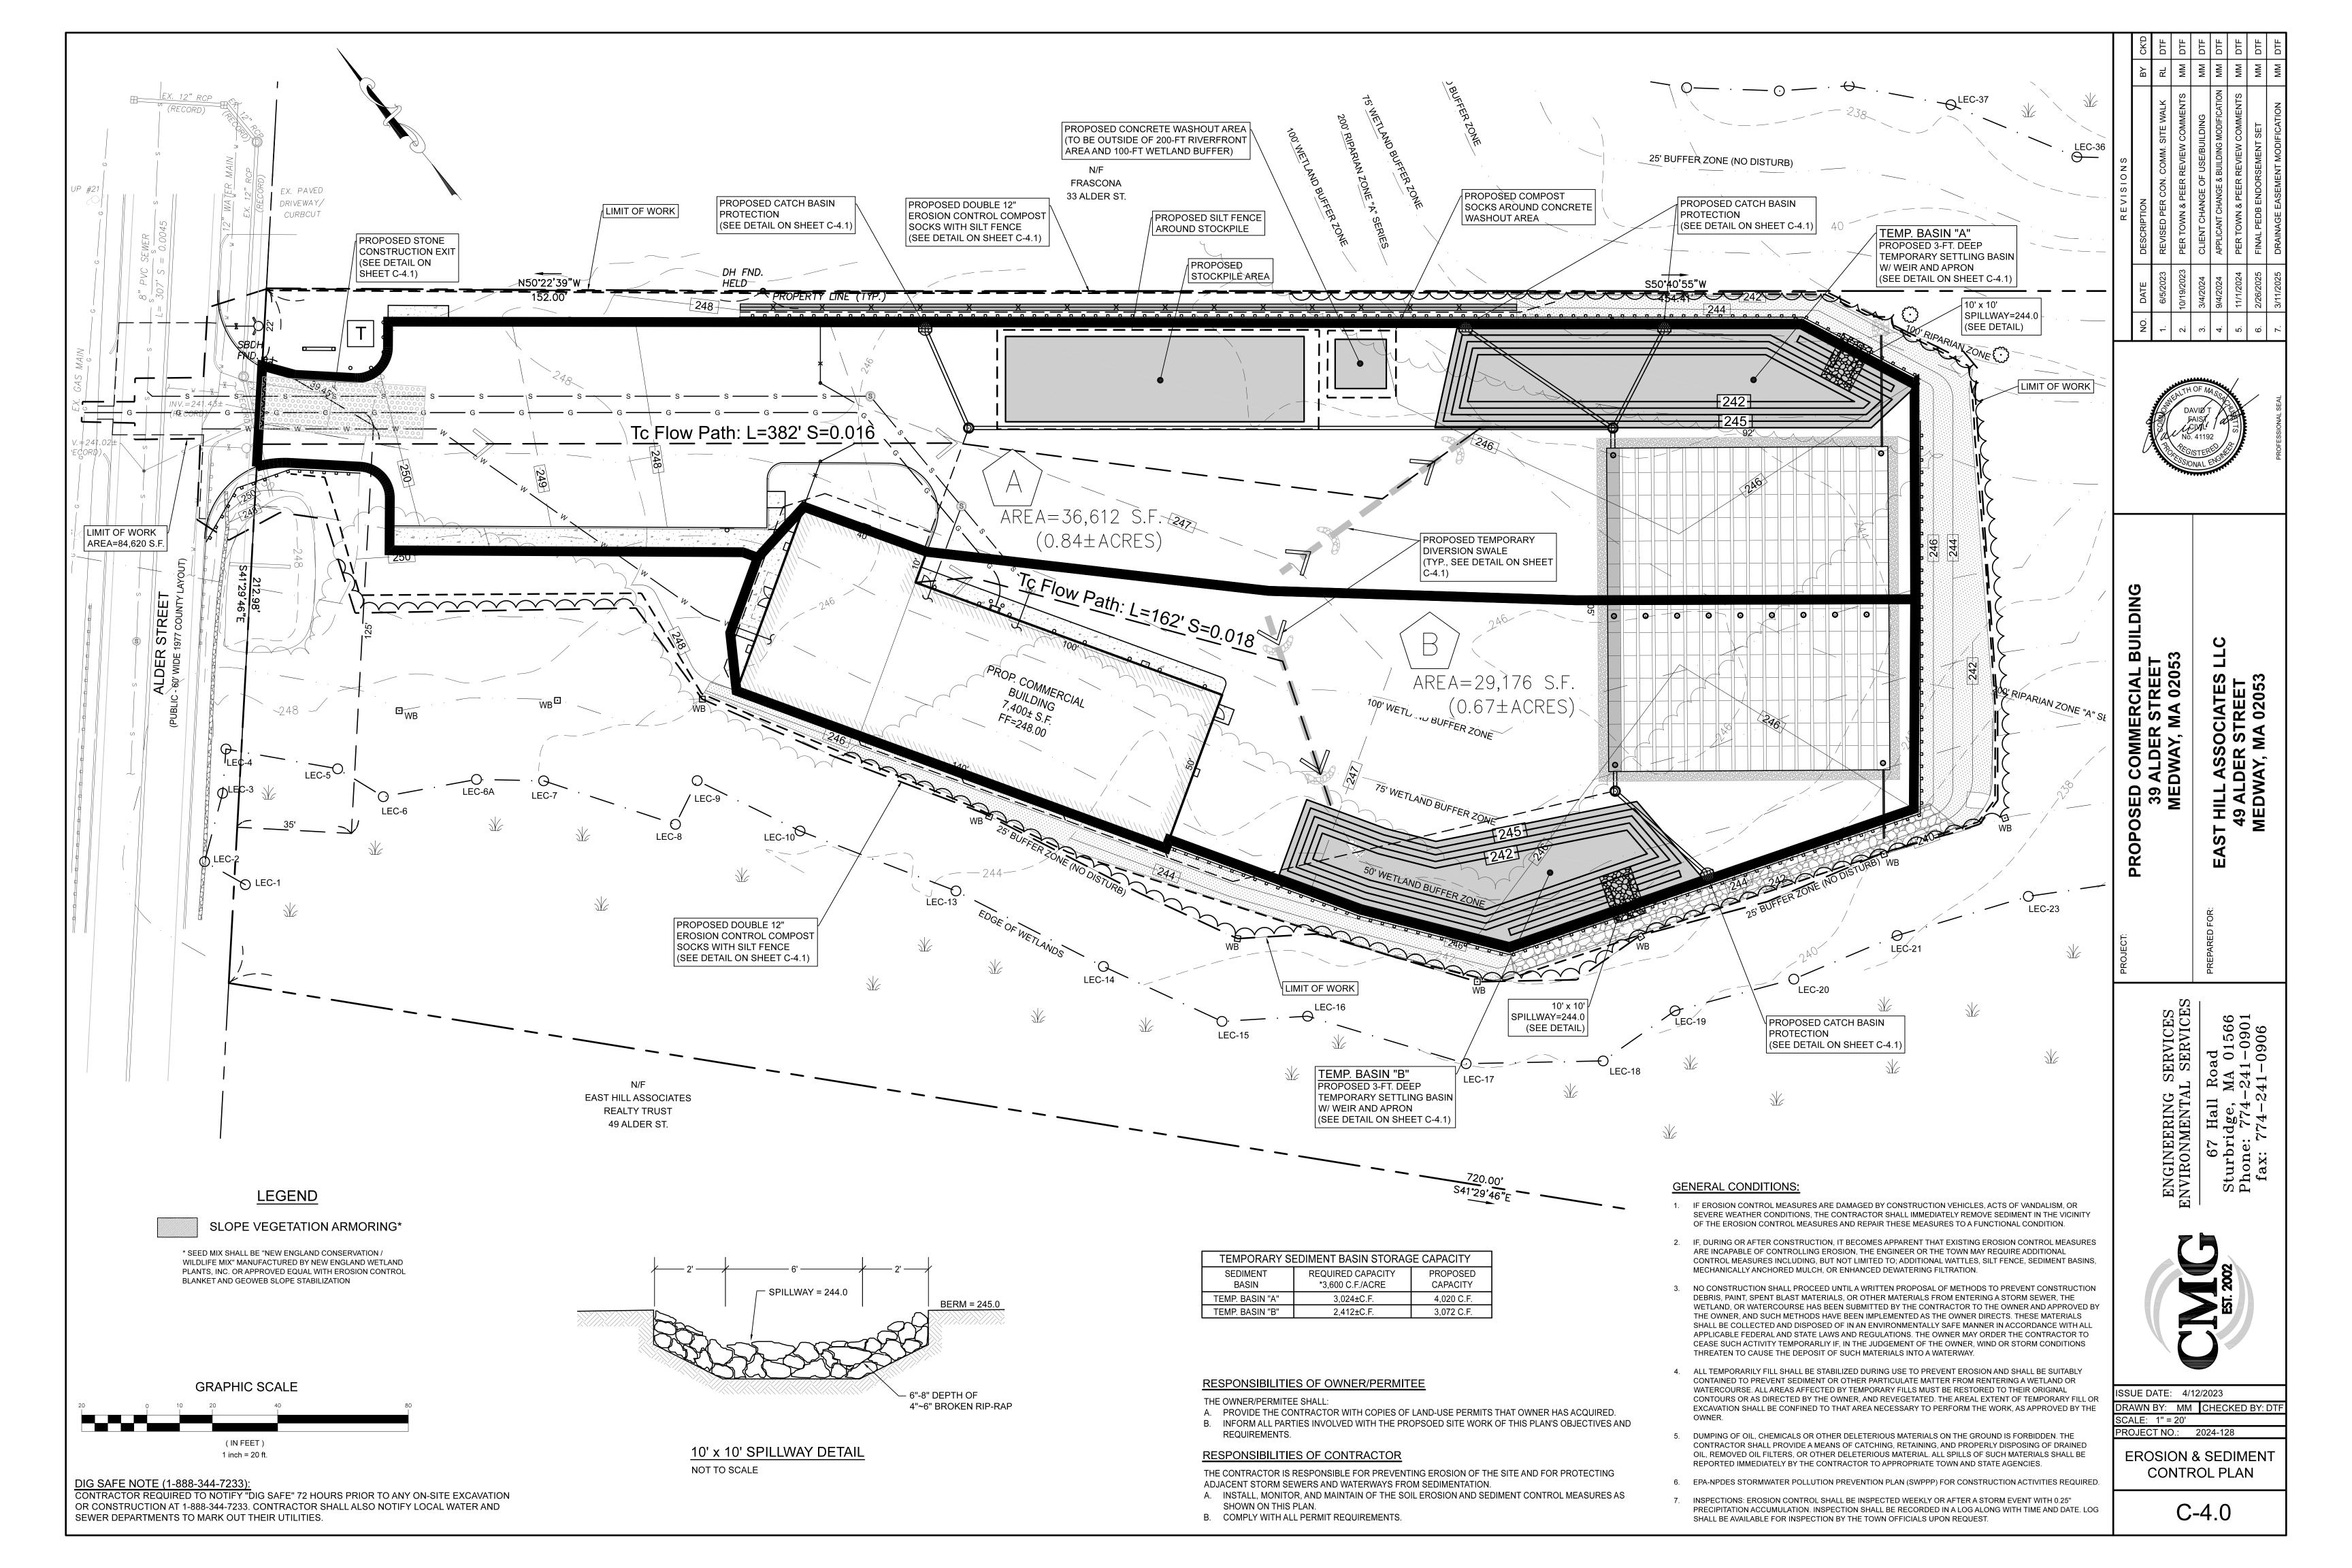
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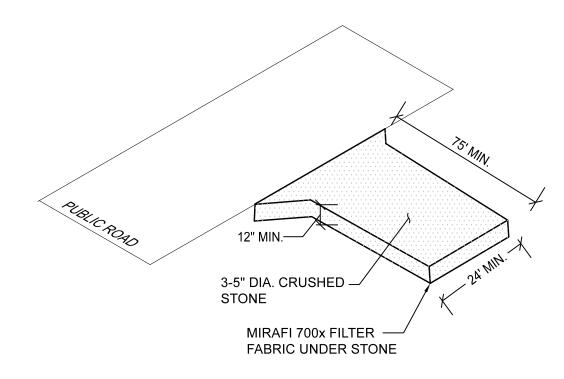







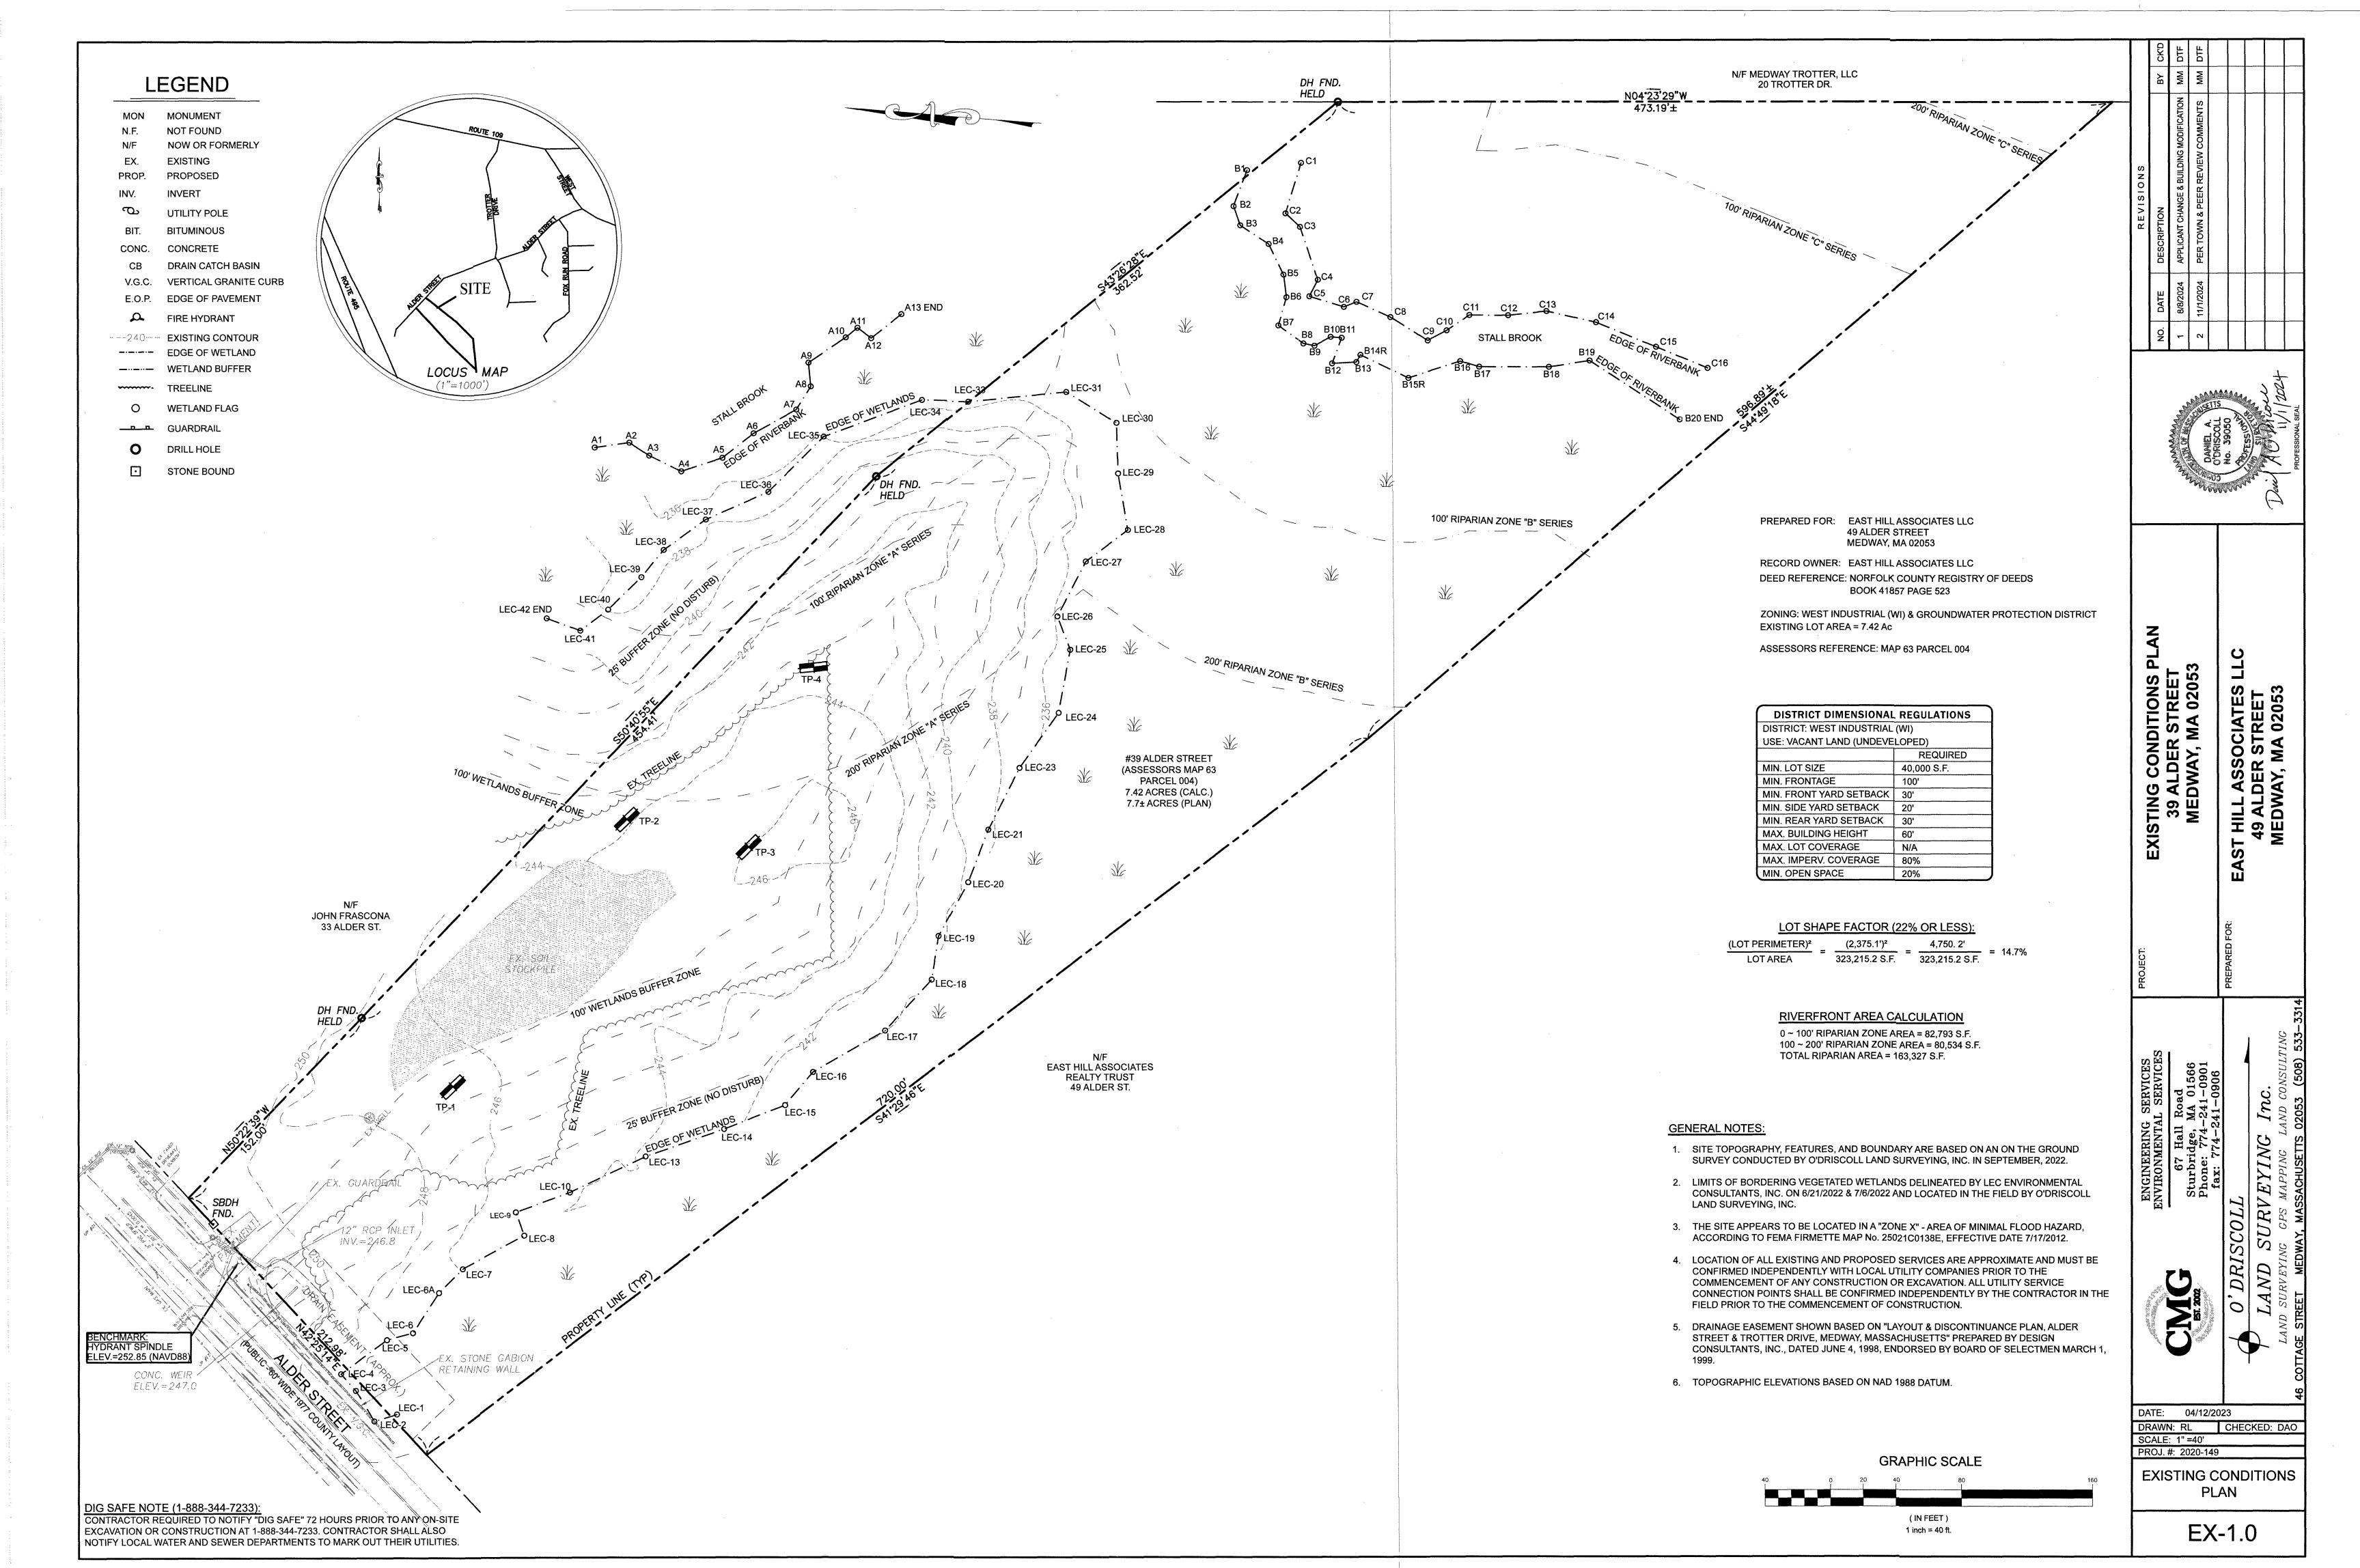

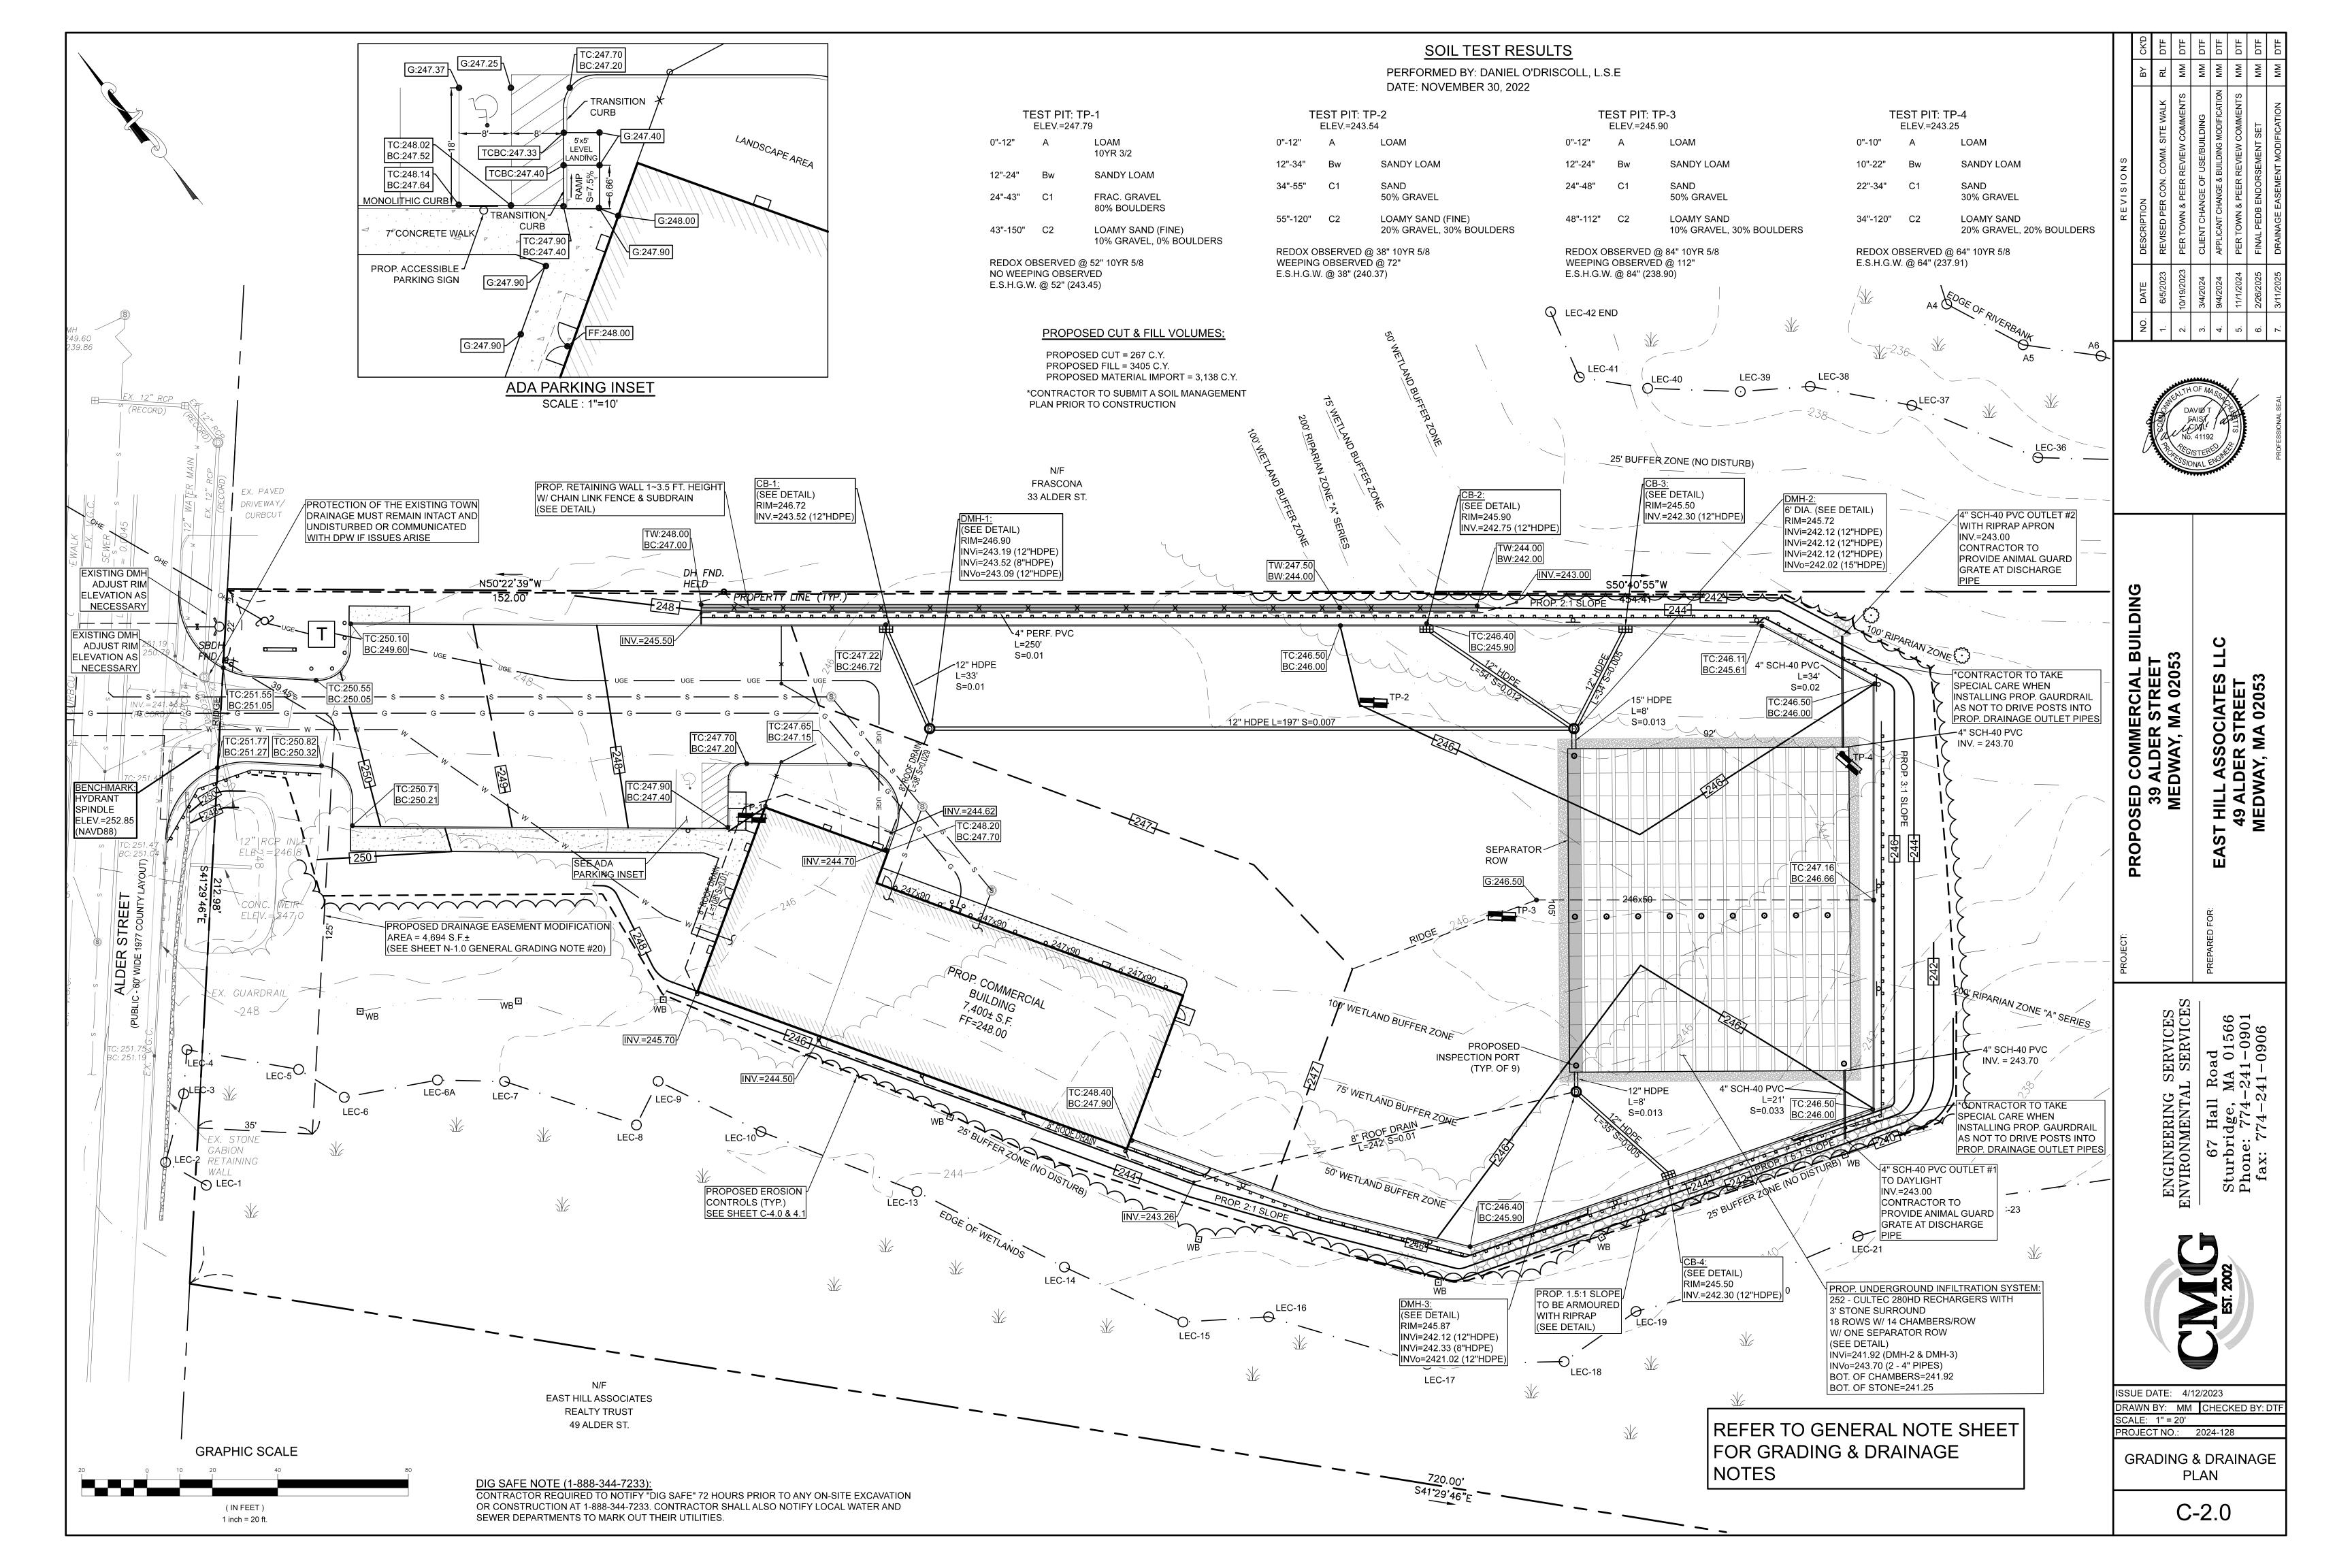SILT SACK DETAIL NOT TO SCALE

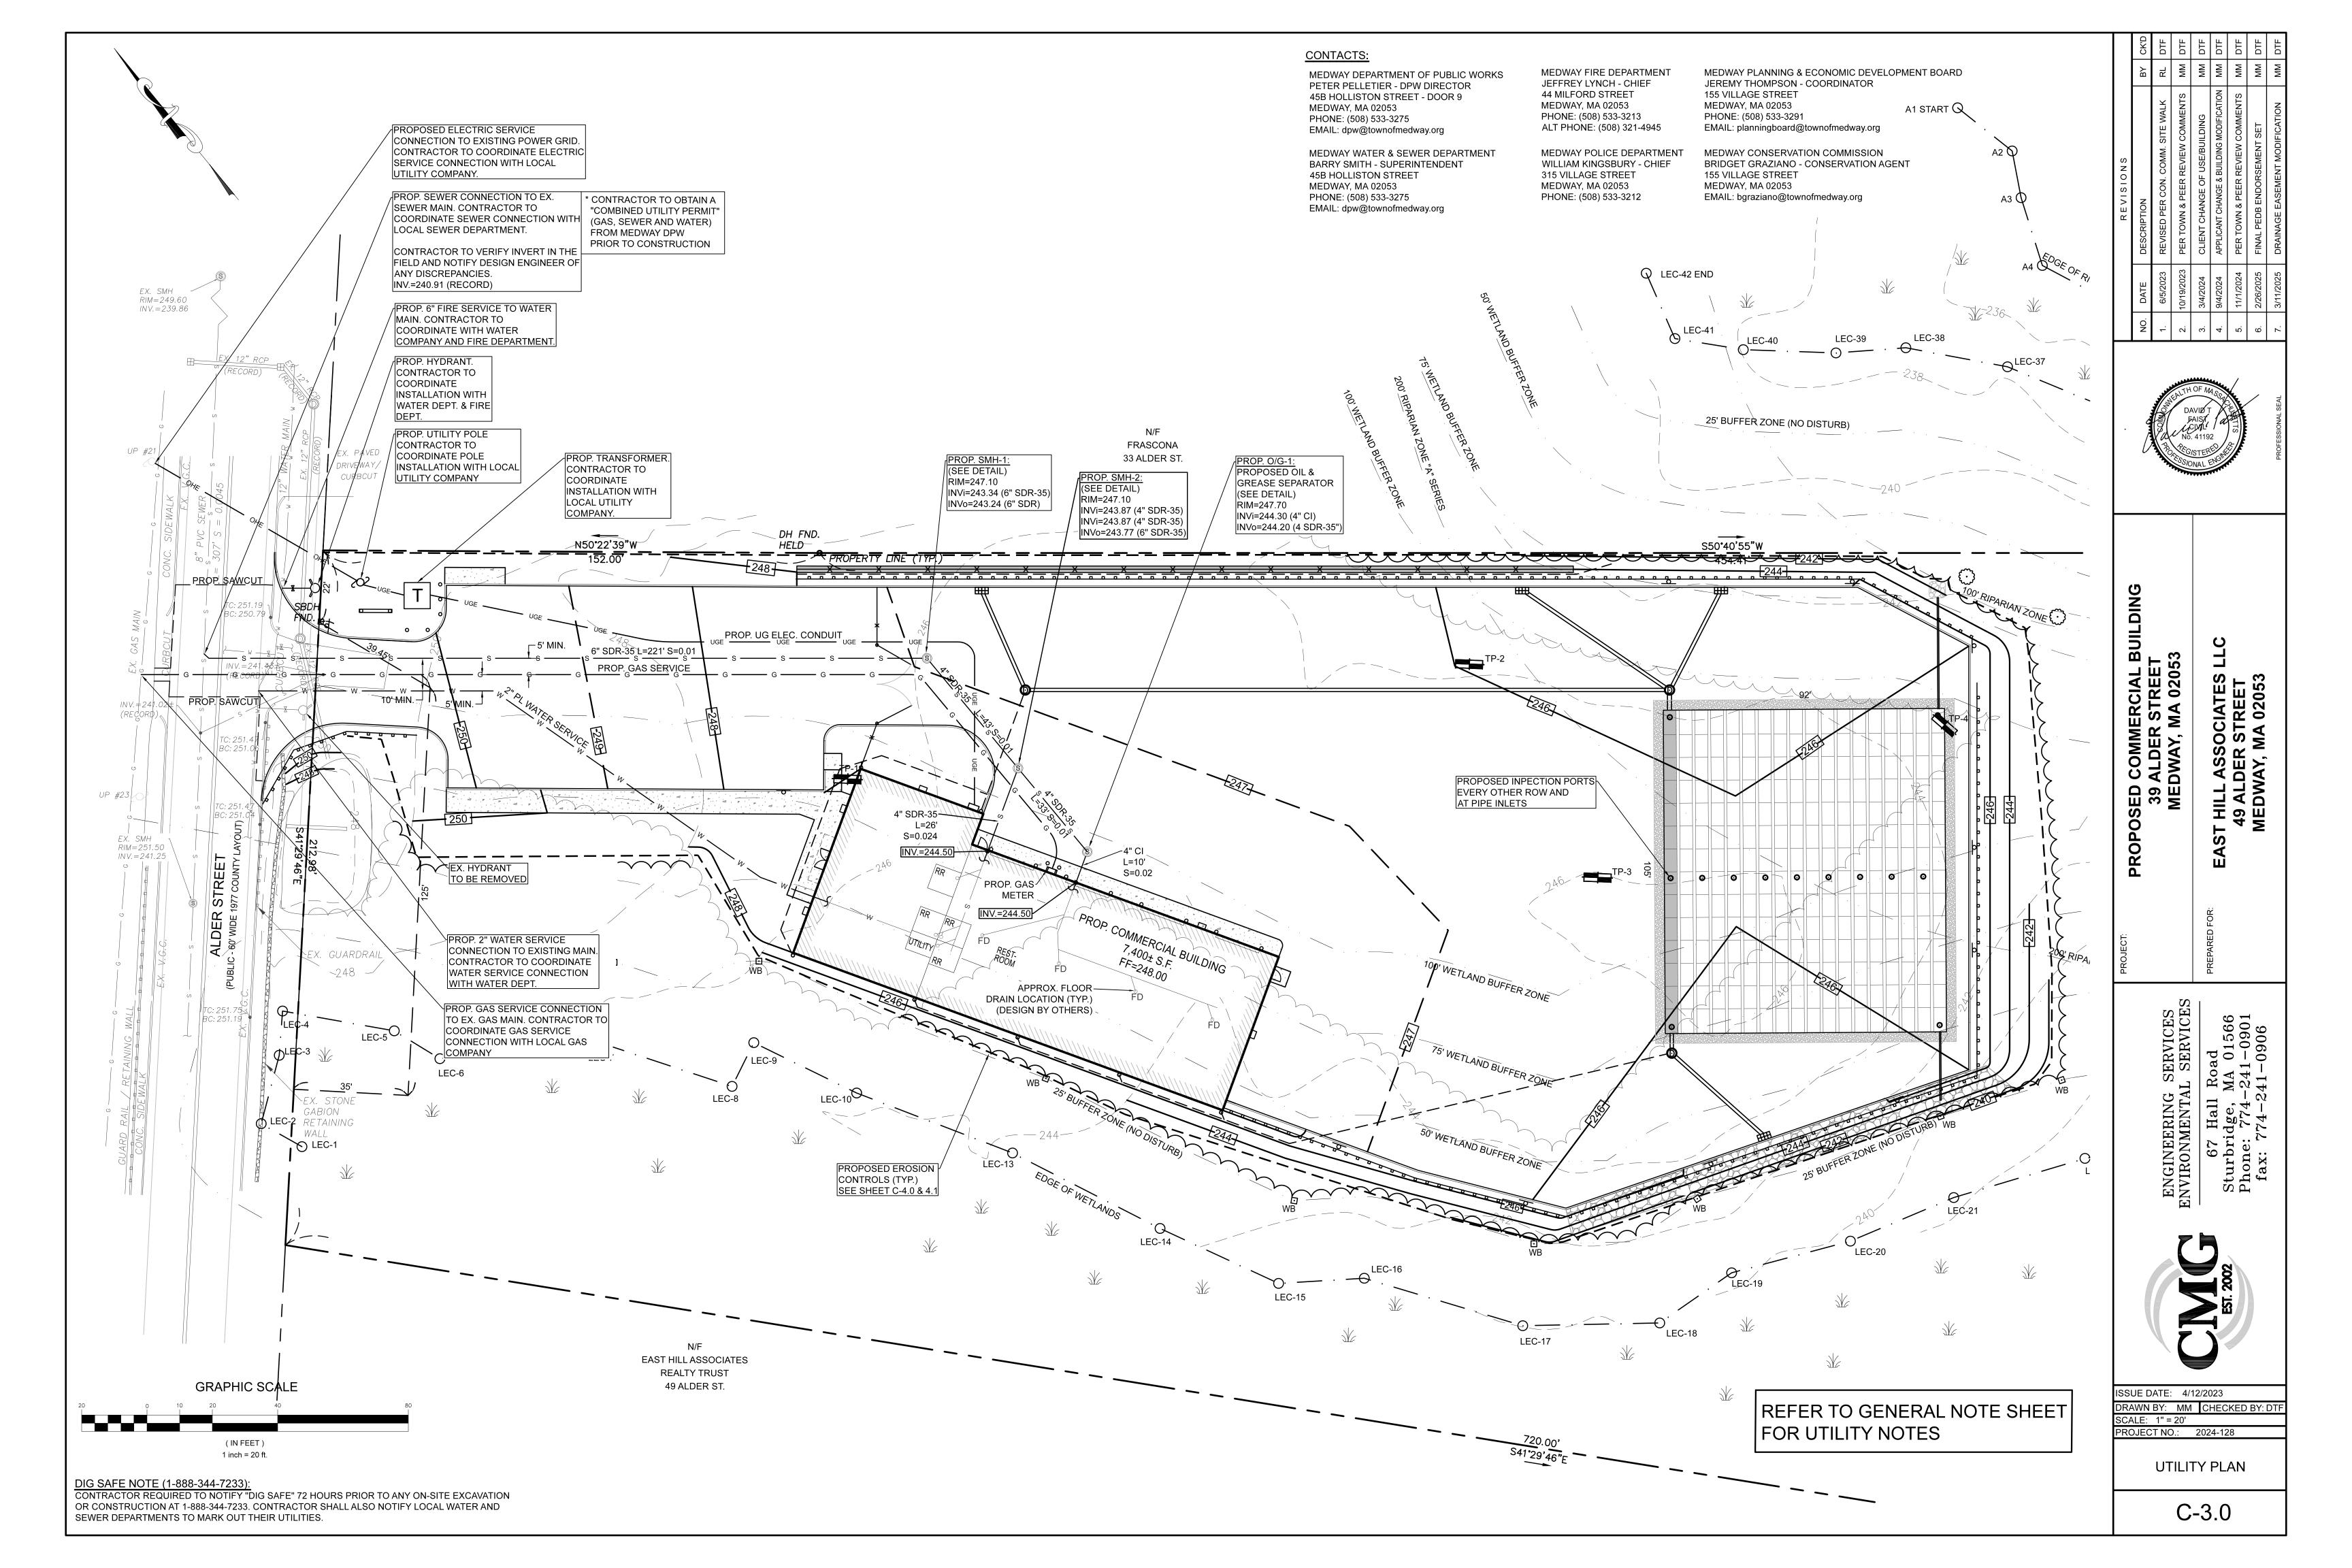


CONSTRUCTION EXIT DETAIL NOT TO SCALE

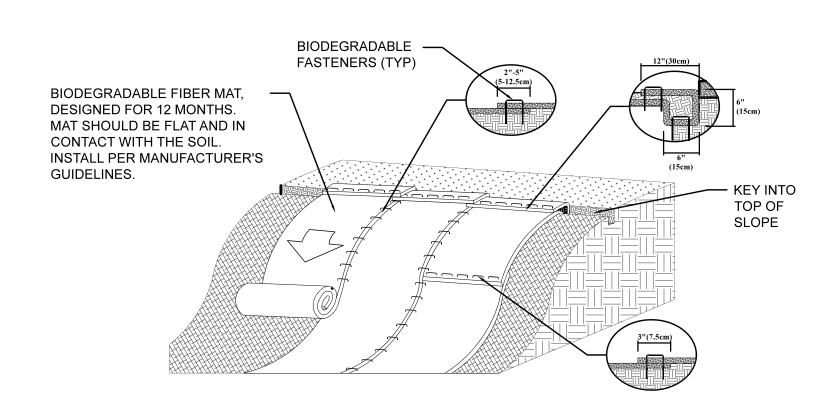


EROSION CONTROL BLANKET DETAIL

NOT TO SCALE

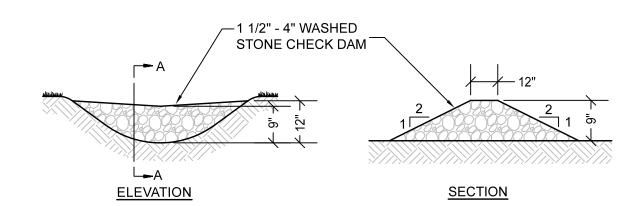

TEMPORARY DIVERSION SWALE WITH STONE CHECK DAM DETAIL NOT TO SCALE

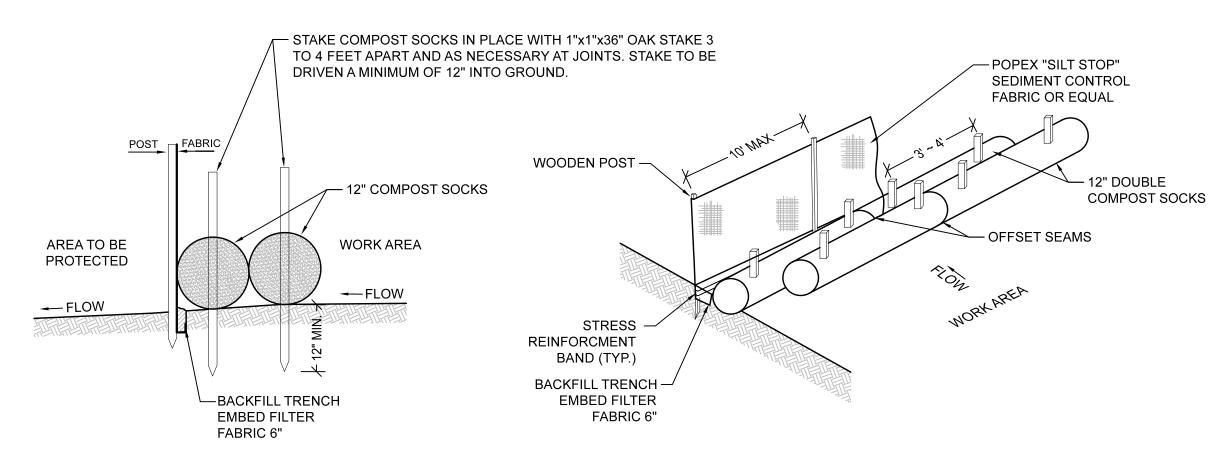

DOUBLE COMPOST SOCKS WITH SILT FENCE DETAIL NOT TO SCALE

1:3 MAXIMUM SLOPE-35' MAXIMUM

TEMPORARY STOCKPILE NOT TO SCALE


CONSTRUCT SILT FENCE AROUND PERIMETER OF STOCKPILE—

4.5' MAX.

SECTION A-A

GEOTEXTILE

FABRIC

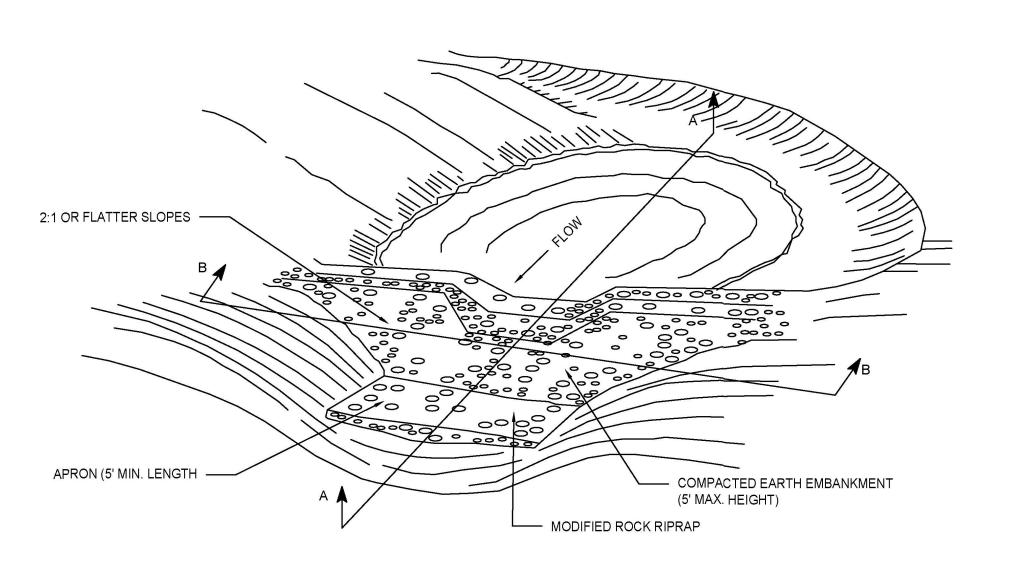

GEOTEXTILE

SECTION B-B

FABRIC

TEMPORARY SEDIMENT BASIN DETAIL

WET POOL ELEV. -

ELEVATION MARK

FOR CLEANOUT

NOT TO SCALE

PROPOSED SEQUENCE OF CONSTRUCTION:

- CONDUCT A PRE-CONSTRUCTION MEETING WITH APPLICABLE TOWN STAFF, PEER REVIEW CONSULTANTS, AND ENGINEER
- OBTAIN ALL APPLICABLE PERMITS FROM THE TOWN AND STATE BEFORE STARTING ANY WORK ON THE SITE.
- INSTALL EROSION CONTROLS AS SHOWN ON THE PLAN AND DETAILS.
- ROUGH GRADE THE SITE AS SHOWN ON THE GRADING AND DRAINAGE PLAN. CONSTRUCT THE PROPOSED BUILDING PER THE SITE PLAN.
- INSTALL ALL SUBSURFACE UTILITIES AND STORMWATER CONVEYANCE/ TREATMENT STRUCTURES. FINALIZE PROPOSED SITE IMPROVEMENTS PER THE APPROVED SITE PLAN. INSTALL GROUND COVER TREATMENT PER THE
- LANDSCAPE PLAN TO STABILIZE ANY DISTURBED AREAS. COORDINATE FINAL APPROVALS WITH ENGINEER OF RECORD & APPLICABLE TOWN DEPARTMENTS. AS-BUILT SURVEY AND
- INSPECTIONS WILL BE REQUIRED PRIOR TO FINAL APPROVAL BY THE TOWN DEPARTMENTS. 9. REMOVE ALL EROSION CONTROL MEASURES FROM THE SITE AND PROPERLY DISPOSE OF MEASURES OFF-SITE.

DESCRIPTION AND MAINTENACE OF EROSION CONTROL MEASURES:

TEMPORARY STABILIZATION MEASURES

SILT FENCING WITH COMPOST SOCKS OR APPROVED EQUAL

INSTALL SILT FENCE/ COMPOST SOCKS AT VARIOUS LOCATIONS AS SHOWN ON THE PLANS AND DETAILS. EMBED THE SILT FENCE AND COMPOST SOCKS INTO THE GROUND AND FIRMLY ANCHOR IT AS SHOWN IN THE DETAILS. REMOVE SEDIMENT ONCE LEVELS HAVE REACHED 1/4 OF THE EFFECTIVE FENCE-HEIGHT. REPAIR AND OR/ REPLACE IMMEDIATELY IF DAMAGED OR DETERIORATED.

PLACE 1 ~ 3" STONE ON A GEOTEXTILE FILTER FABRIC ALONG A STABLE FOUNDATION. ENTRANCE SHALL BE INSPECTED WEEKLY OR AFTER A HEAVY RAIN EVENT. MUD AND SEDIMENT TRACKED OR WASHED ONTO THE PUBLIC ROADWAY MUST BE REMOVED IMMEDIATELY. ONCE MUD AND SOIL PARTICLES CLOG THE VOIDS IN THE GRAVEL, THE PAD SHOULD BE TOP DRESSED WITH STONE. RESHAPE PAD AS NEEDED FOR DRAINAGE AND RUNOFF CONTROL.

SILT SACK DROP INLET PROTECTION:

SILT SACK OR APPLICABLE FABRIC DROP INLET PROTECTION DEVICE SHALL BE INSTALLED PER THE MANUFACTURER'S SPECIFICATIONS. TRAPPING DEVICES AND STRUCTURES THEY PROTECT SHOULD BE INSPECTED AFTER EVERY RAIN STORM AND REPAIRS MADE AS NECESSARY, SEDIMENT SHOULD BE REMOVED FROM THE TRAPPING DEVICES AFTER THE SEDIMENT HAS REACHED A MAXIMUM OF ONE HALF THE DEPTH OF THE TRAP.

TEMPORARY STABILIZATION:

TOP SOIL STOCKPILES AND DISTURBED PORTIONS OF THE SITE WHERE CONSTRUCTION ACTIVITY CEASES FOR AT LEAST 21 DAYS WILL BE STABILIZED WITH TEMPORARY SEED AND MULCH NO LATER THAN 14 DAYS FROM THE LAST CONSTRUCTION ACTIVITY IN THAT AREA. THE TEMPORARY SEED AND MULCH PROCEDURES AND SPECIFICATIONS SHALL BE IN ACCORDANCE WITH THE LANDSCAPE ARCHITECT'S RECOMMENDATIONS, AREAS OF THE SITE WHICH ARE TO BE PAVED WILL BE TEMPORARILY STABILIZED BY APPLYING GEOTEXTILE AND STONE SUB-BASE UNTIL BITUMINOUS PAVEMENT CAN BE APPLIED.

DUST CONTROL: TAKE PRECAUTIONS TO PREVENT DUST FROM BECOMING A NUISANCE TO ABUTTING PROPERTY OWNERS. BROOM OFF PAVEMENTS ADJOINING THE EXCAVATION ON A DAILY BASIS. COVER AND/OR KEEP MOIST ALL EARTH STOCKPILES AT ALL TIMES. USE CALCIUM CHLORIDE TO CONTROL DUST OVER CERTAIN AREAS OF THE SITE, AS DIRECTED BY THE ENGINEER OR SHOWN ON THE PLANS. CALCIUM CHLORIDE SHALL CONFORM TO ASTM D-98, TYPE I. THE CONTRACTOR SHALL MAINTAIN AND INSPECT, ON A DAILY BASIS, THE ADEQUACY OF DUST CONTROL MEASURES AND CORRECT ANY DEFICIENCIES IMMEDIATELY.

STOCKPILING OR STORAGE OF EXCAVATED MATERIALS:

COMPLETELY SURROUND TEMPORARY MATERIAL STOCKPILES WITH STRAW WATTLES TO PREVENT TRANSPORTATION OF SEDIMENT.

PERMANENT STABILIZATION MEASURES

DISTURBED PORTIONS OF THE SITE WHERE CONSTRUCTION ACTIVITIES PERMANENTLY CEASE SHALL BE STABILIZED WITH PERMANENT SEED NO LATER THAN 14 DAYS AFTER THE LAST CONSTRUCTION ACTIVITY. THE PERMANENT SEED AND MULCH SPECIFICATIONS AND PROCEDURE SHALL BE IN ACCORDANCE WITH THE LANDSCAPE ARCHITECT'S RECOMMENDATIONS.

THE CONTRACTOR SHALL BE RESPONSIBLE FOR ALL LANDSCAPED AREAS. IF TOPSOIL, SEED, AND/OR MULCH IS WASHED AWAY BY RAINFALL, THE CONTRACTOR SHALL RESTORE THE AREA.

GENERAL CONTROLS:

THE CONTRACTOR SHALL PROVIDE AN ADEQUATE NUMBER OF COVERED WASTE CONTAINERS TO ENSURE THAT NO LITTER, DEBRIS, BUILDING MATERIALS, OR SIMILIAR MATERIALS ARE DISCHARGED TO WETLANDS OR WATERCOURSES. THE CONTRACTOR SHALL INSTRUCT SUBCONTRACTORS TO USE THE CONTAINERS FOR WASTE MATERIAL. THE CONTRACTOR SHALL BE PROMPTLY EMPTIED WHEN FULL.

PAVEMENT MAINTENANCE:

THE CONTRACTOR SHALL SWEEP PAVED ROADWAYS ADJACENT TO THE SITE ON A ROUTINE BASIS TO PREVENT TRACKING OF MUD ONTO PUBLIC ROADWAYS AND WASHING OF MUD INTO WATERWAYS. IF THE CONTRACTOR'S SCHEDULE FOR CLEANING THE PAVEMENT IS FOUND TO BE INADEQUATE BY THE OWNER, OWNER'S REPRESENTATIVE, OR TOWN, THE CONTRACTOR SHALL INCREASE THE FREQUENCY AT NO ADDITIONAL COST TO THE OWNER.

PROHIBITED DISCHARGES:


CONTRACTOR SHALL PREVENT DAILY CONSTRUCTION MATERIALS AND WASTE FROM ENTERING ANY WETLANDS OR WATERCOURSES, INCLUDING BUT NOT LIMITED TO; CONTAMINATED GROUNDWATER, CONCRETE WASHOUT, FUELS, SOAPS OR SOLVENTS, PAINT, TOXIC SUBSTANCES, ETC.

EXCAVATION DEWATERING:

CONTRACTOR SHALL NOT DISCHARGE DEWATERING MEASURES DIRECTLY INTO WETLANDS AND WATERCOURSES. CONTRACTOR TO UTILIZE ON-SITE INFILTRATION BASINS WITH VELOCITY DISSIPATION DEVICES TO PROPERLY SETTLE DEWATERING FLUIDS. TREATMENT CHEMICALS ARE PROHIBITED FROM ENTERING THE SETTLING BASIN AND MUST BE HANDLED ACCORDING TO APPLICABLE RIDEM REGULATIONS.

GENERAL CONDITIONS

- 1. IF EROSION CONTROL MEASURES ARE DAMAGED BY CONSTRUCTION VEHICLES, ACTS OF VANDALISM, OR SEVERE WEATHER CONDITIONS, THE CONTRACTOR SHALL IMMEDIATELY REMOVE SEDIMENT IN THE VICINITY OF THE EROSION CONTROL MEASURES AND REPAIR THESE MEASURES TO A FUNCTIONAL CONDITION.
- 2. IF, DURING OR AFTER CONSTRUCTION, IT BECOMES APPARENT THAT EXISTING EROSION CONTROL MEASURES ARE INCAPABLE OF CONTROLLING EROSION, THE ENGINEER OR THE TOWN MAY REQUIRE ADDITIONAL CONTROL MEASURES INCLUDING, BUT NOT LIMITED TO; ADDITIONAL WATTLES, SILT FENCE, SEDIMENT BASINS, MECHANICALLY ANCHORED MULCH, OR ENHANCED DEWATERING FILTRATION.
- NO CONSTRUCTION SHALL PROCEED UNTIL A WRITTEN PROPOSAL OF METHODS TO PREVENT CONSTRUCTION DEBRIS, PAINT, SPENT BLAST MATERIALS, OR OTHER MATERIALS FROM ENTERING A STORM SEWER, THE WETLAND, OR WATERCOURSE HAS BEEN SUBMITTED BY THE CONTRACTOR TO THE OWNER AND APPROVED BY THE OWNER, AND SUCH METHODS HAVE BEEN IMPLEMENTED AS THE OWNER DIRECTS. THESE MATERIALS SHALL BE COLLECTED AND DISPOSED OF IN AN ENVIRONMENTALLY SAFE MANNER IN ACCORDANCE WITH ALL APPLICABLE FEDERAL AND STATE LAWS AND REGULATIONS. THE OWNER MAY ORDER THE CONTRACTOR TO CEASE SUCH ACTIVITY TEMPORARLIY IF, IN THE JUDGEMENT OF THE OWNER, WIND OR STORM CONDITIONS THREATEN TO CAUSE THE DEPOSIT OF SUCH MATERIALS INTO A WATERWAY.
- 4. ALL TEMPORARILY FILL SHALL BE STABILIZED DURING USE TO PREVENT EROSION AND SHALL BE SUITABLY CONTAINED TO PREVENT SEDIMENT OR OTHER PARTICULATE MATTER FROM RENTERING A WETLAND OR WATERCOURSE. ALL AREAS AFFECTED BY TEMPORARY FILLS MUST BE RESTORED TO THEIR ORIGINAL CONTOURS OR AS DIRECTED BY THE OWNER, AND REVEGETATED. THE AREAL EXTENT OF TEMPORARY FILL OR EXCAVATION SHALL BE CONFINED TO THAT AREA NECESSARY TO PERFORM THE WORK, AS APPROVED BY THE OWNER.
- DUMPING OF OIL, CHEMICALS OR OTHER DELETERIOUS MATERIALS ON THE GROUND IS FORBIDDEN. THE CONTRACTOR SHALL PROVIDE A MEANS OF CATCHING, RETAINING, AND PROPERLY DISPOSING OF DRAINED OIL, REMOVED OIL FILTERS, OR OTHER DELETERIOUS MATERIAL. ALL SPILLS OF SUCH MATERIALS SHALL BE REPORTED IMMEDIATELY BY THE CONTRACTOR TO APPROPRIATE TOWN AND STATE AGENCIES.
- 6. EPA-NPDES STORMWATER POLLUTION PREVENTION PLAN (SWPPP) FOR CONSTRUCTION ACTIVITIES REQUIRED.
- 7. INSPECTIONS: EROSION CONTROL SHALL BE INSPECTED WEEKLY OR AFTER A LEGITIMATE STORM EVENT. INSPECTION SHALL BE RECORDED IN A LOG ALONG WITH TIME AND DATE. LOG SHALL BE AVAILABLE FOR INSPECTION BY THE TOWN OFFICIALS UPON REQUEST.
- 8. CONTRACTOR TO NOTIFY MEDWAY CONSERVATION COMMISSION IF FILL MATERIALS ARE TO BE IMPORTED.

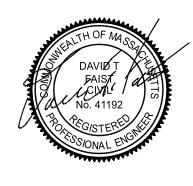

CIAL TREE





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PROJECT NO.: 2024-128

EROSION & SEDIMENT CONTROL DETAILS


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SEWER TRENCH DETAIL

NOT TO SCALE

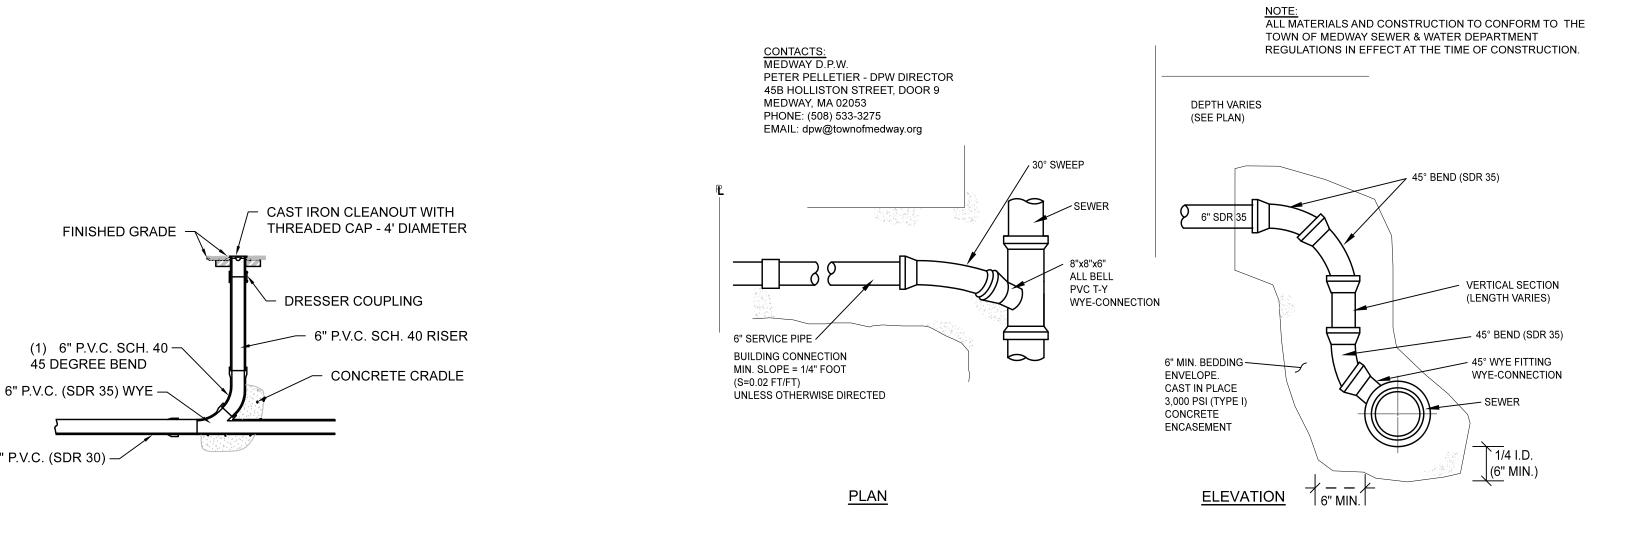

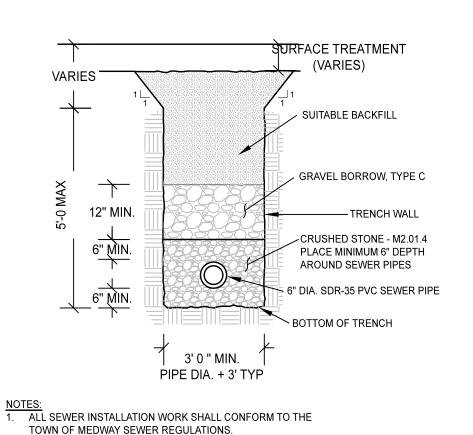1. THIS DETAIL APPLIES TO CONSTRUCTION OF WATER, GAS, TELEPHONE, ELECTRIC, AND CABLE TELEVISION UTILITIES. UNLESS DIRECTED OTHERWISE BY APPLICABLE UTILITY COMPANIES.


2. PROVIDE 5' MINIMUM COVER OVER WATER SERVICE LINE UNLESS DIRECTED OTHERWISE BY WATER COMPANY.

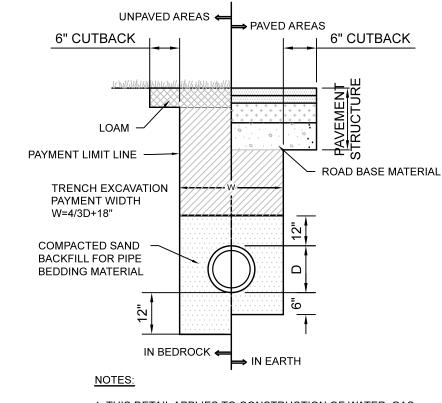
UTILITY TRENCH DETAIL NOT TO SCALE


CLEANOUT DETAIL NOT TO SCALE

GRAVITY BUILDING SERVICE CONNECTION DETAIL

NOT TO SCALE

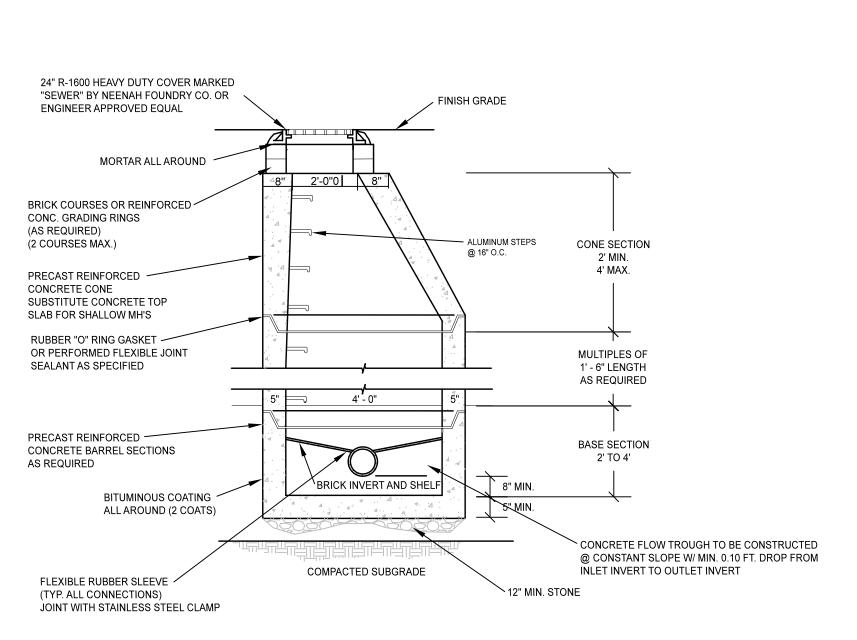

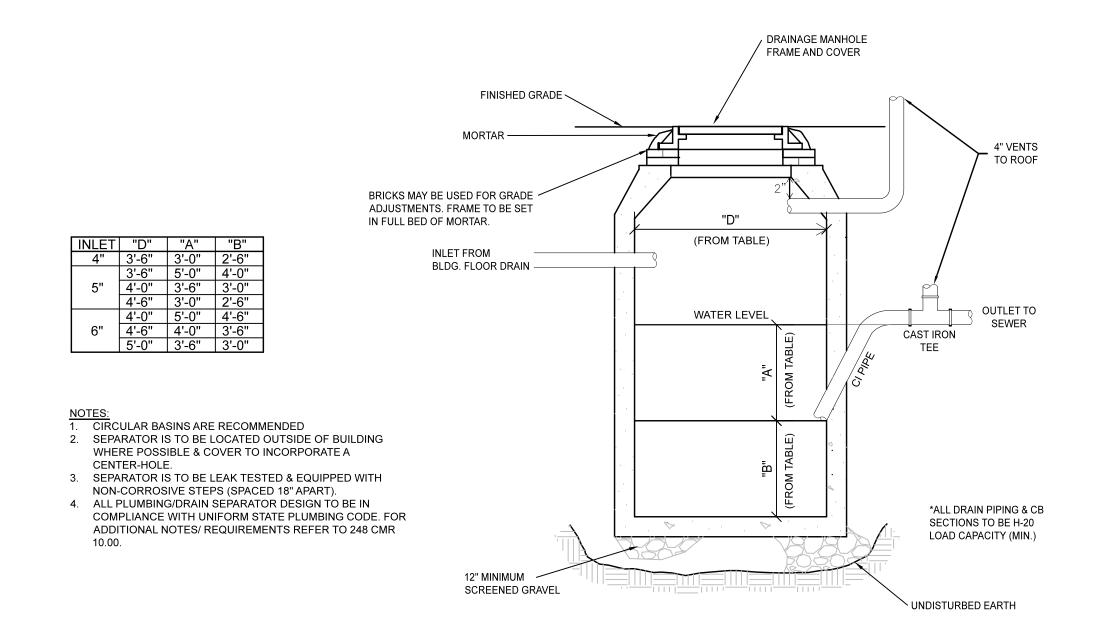


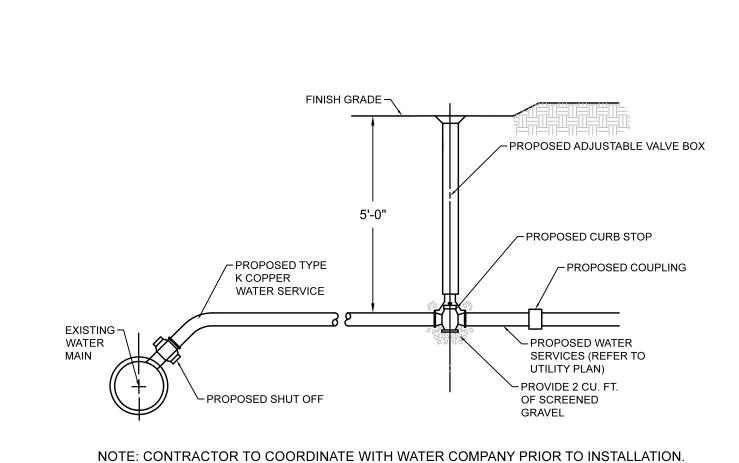

WATER SERVICE CONSTRUCTION DETAIL NOT TO SCALE

PRECAST SEWER MANHOLE DETAIL

NOT TO SCALE

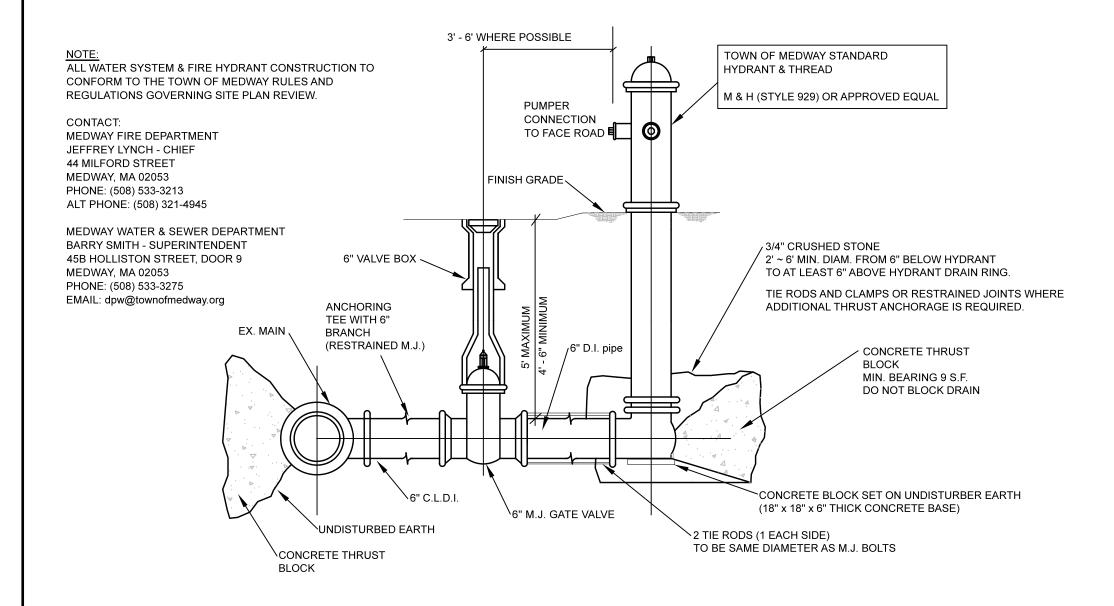

2' SQ X 6" THICK CLASS -B CONCRETE PAD VALVE BOX TO SUIT VALVE AND DEPTH OF BURY - ADJUST TOP SECTION TO FINISH GRADE TAMP BACKFILL VALVE BODY -WATER PIPE J VALVE BOX TO BE ENTIRELY -SUPPORTED BY CONCRETE BLOCKS OR BRICKS TO SUIT. VALVE BOX MUST NOT BEAR ON VALVE OR PIPE.

TYPICAL OIL/ GREASE SEPARATOR DETAIL

NOT TO SCALE

WATER GATE VALVE DETAIL NOT TO SCALE

ENGINEERING SERVICES
ENVIRONMENTAL SERVICES
67 Hall Road
Sturbridge, MA 01566
Phone: 774-241-0901
fax: 774-241-0906

BUILDING

PROPO

CIAL FREE




DRAWN BY: MM CHECKED BY: DT SCALE: NONE PROJECT NO.: 2024-128 CONSTRUCTION **DETAILS**

ISSUE DATE: 4/12/2023


C-5.0

FIRE HYDRANT DETAIL NOT TO SCALE

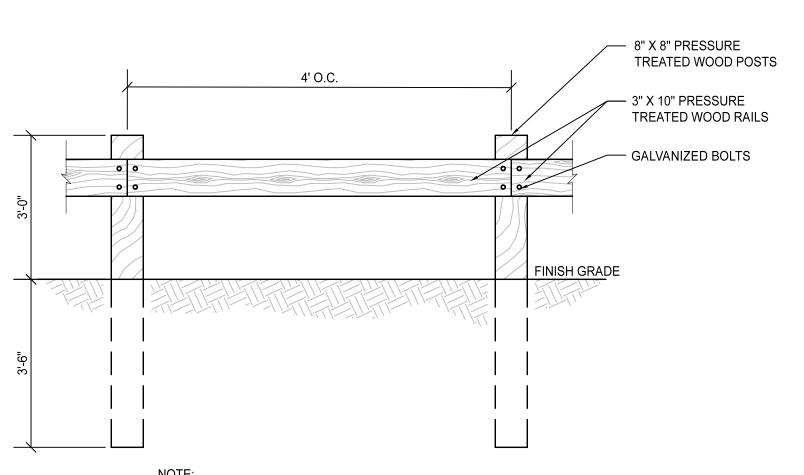


NOTE:
GENERAL CONTRACTOR TO SUBMIT SHOP DRAWING TO ARCHITECT/ ENGINEER FOR APPROVAL

TIMBER GUARDRAIL DETAIL
NOT TO SCALE

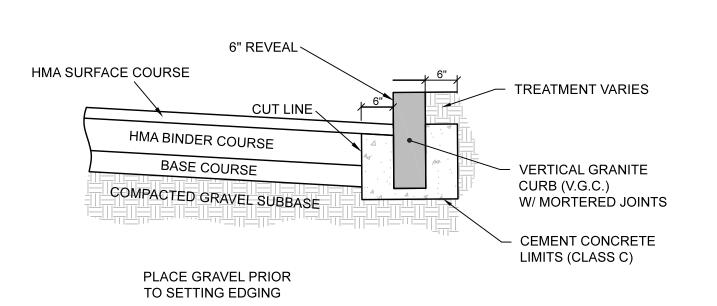

VERTICAL GRANITE CURB DETAIL


NOT TO SCALE

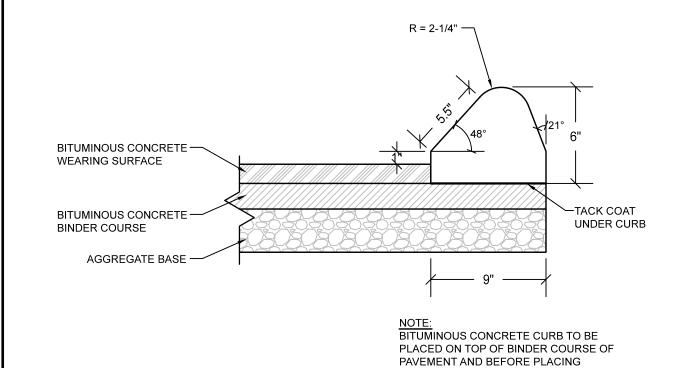

BITUMINOUS CURB DETAIL


WEARING SURFACE LAYER

NOT TO SCALE

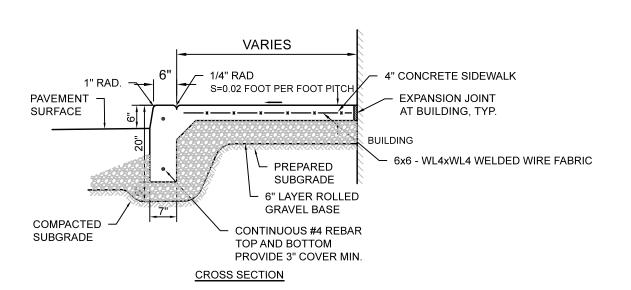


MONOLITHIC CONC. CURB DETAIL

NOT TO SCALE

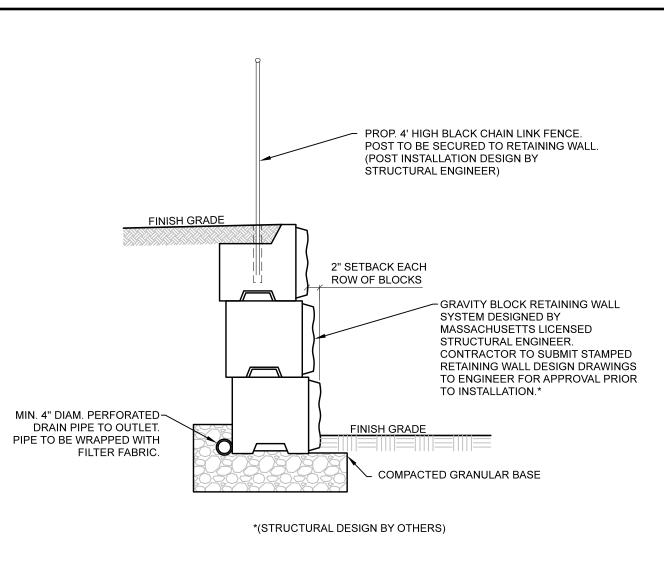


TYPICAL BLOCK RETAINING WALL DETAIL

NOT TO SCALE

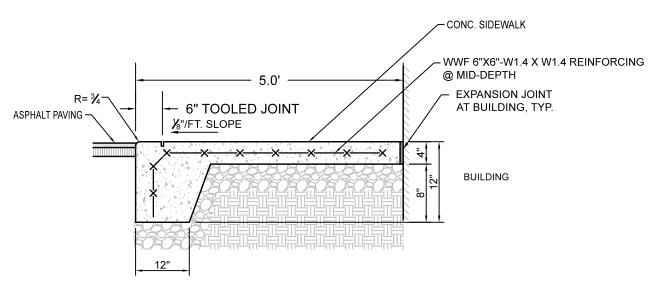


CONCRETE APRON AT BUILDING DETAIL

NOT TO SCALE

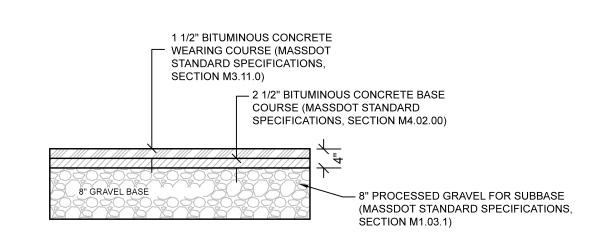


ASPHALT PAVEMENT DETAIL

NOT TO SCALE

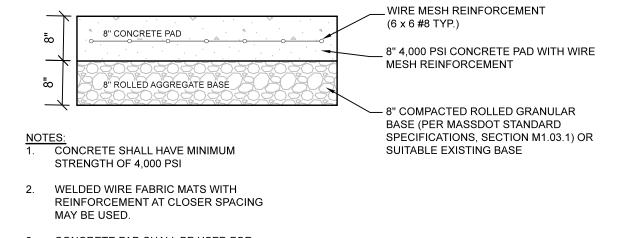


3. CONCRETE PAD SHALL BE USED FOR GENERATOR PAD AND DUMPSTER PAD.

CONCRETE PAD DETAIL
NOT TO SCALE

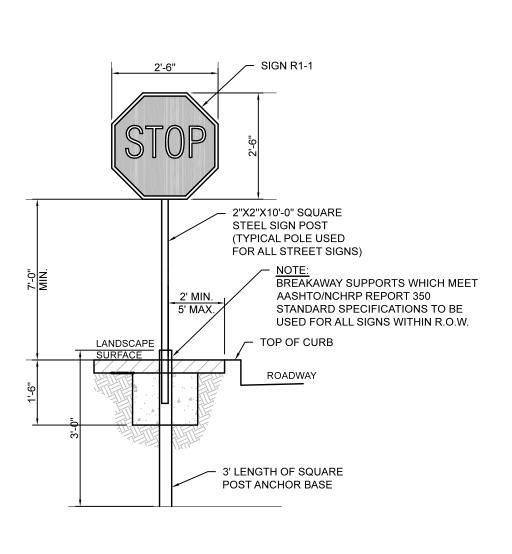


TYPICAL TRAFFIC SIGN DETAIL


NOT TO SCALE

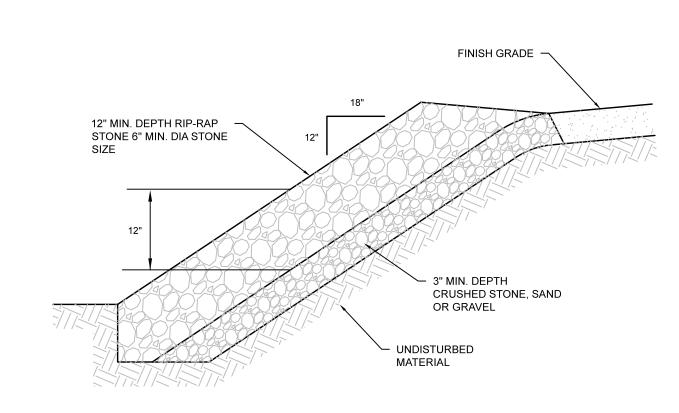

1.5:1 RIP-RAP SLOPE PROTECTION DETAIL NOT TO SCALE

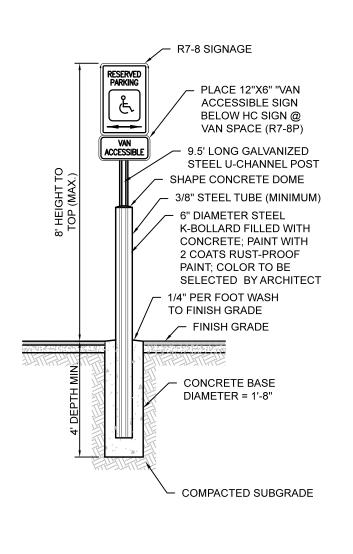

HANDICAP PARKING SIGN DETAIL
NOT TO SCALE

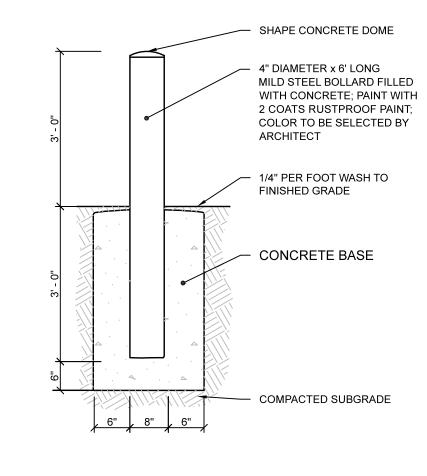

STEEL PIPE BOLLARD DETAIL

NOT TO SCALE

		REVISIONS		
NO.	DATE	DESCRIPTION	ВУ	CK'D
1.	6/5/2023	REVISED PER CON. COMM. SITE WALK	RL	DTF
2.	10/19/2023	PER TOWN & PEER REVIEW COMMENTS	MM	DTF
3.	3/4/2024	CLIENT CHANGE OF USE/BUILDING	MM	DTF
4.	9/4/2024	APPLICANT CHANGE & BUILDING MODIFICATION	MM	DTF
5.	11/1/2024	PER TOWN & PEER REVIEW COMMENTS	MM	DTF
9.	2/26/2025	FINAL PEDB ENDORSEMENT SET	MM	DTF
7.	3/11/2025	DRAINAGE EASEMENT MODIFICATION	MM	DTF



PROPOSED COMMERCIAL BUILDING 39 ALDER STREET MEDWAY, MA 02053	EAST HILL ASSOCIATES LLC 49 ALDER STREET
	OR:


INEERING SERVICES RONMENTAL SERVICES	67 Hall Road urbridge, MA 01566 one: 774-241-0901 ax: 774-241-0906




ISSUE DATE: 4/12	2/2023
DRAWN BY: MM	CHECKED BY: DT
SCALE: NONE	
PROJECT NO.: 2	2024-128
CONSTR	RUCTION

DETAILS


C-5.1

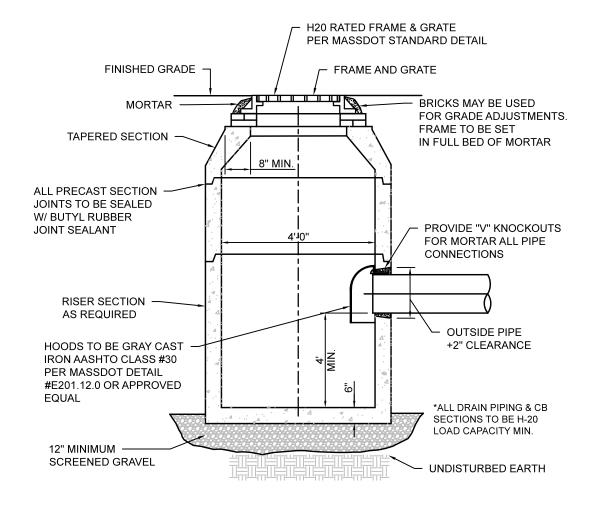

DEEP SUMP CATCH BASIN DETAIL
NOT TO SCALE

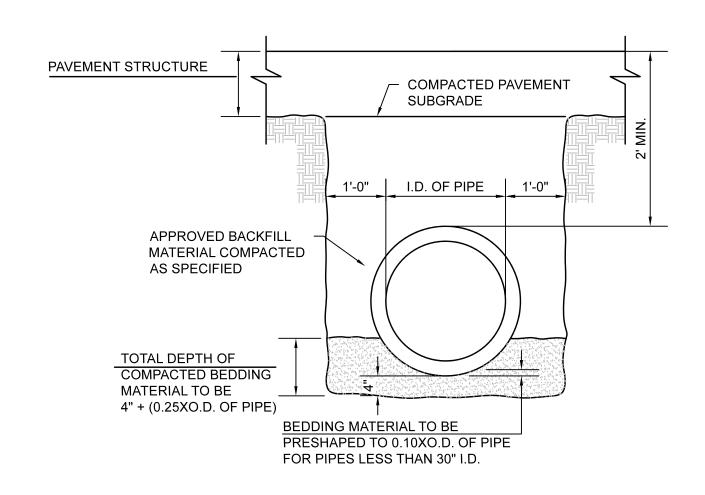


STORM SEWER TRENCH DETAIL NOT TO SCALE

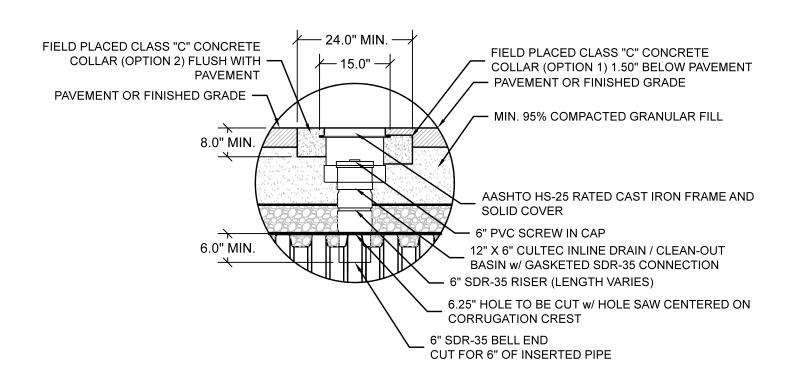


TYPICAL INSPECTION PORT DETAIL

NOT TO SCALE

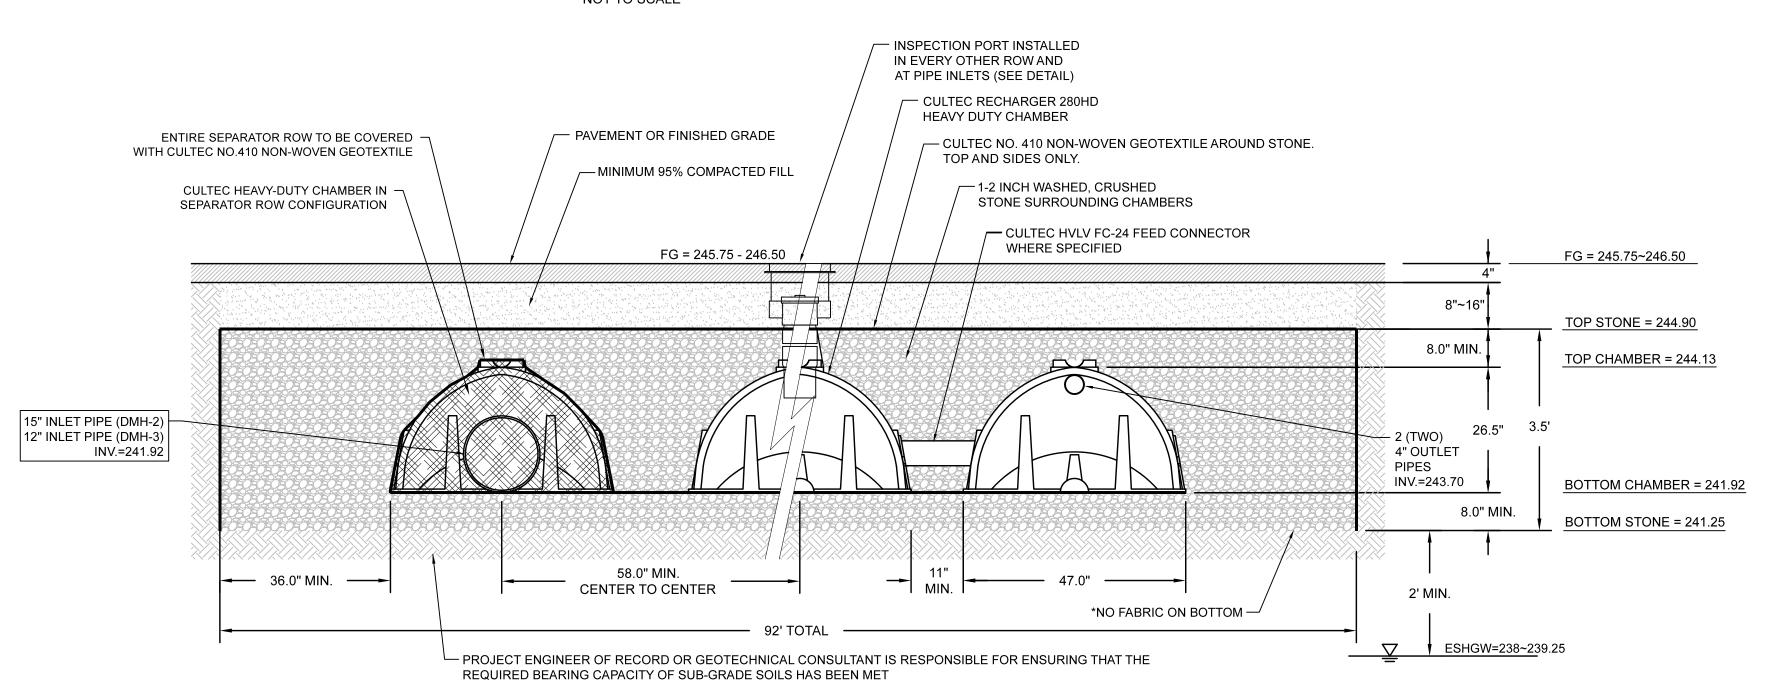


UNDERGROUND INFILTRATION CHAMBER DETAIL

NOT TO SCALE

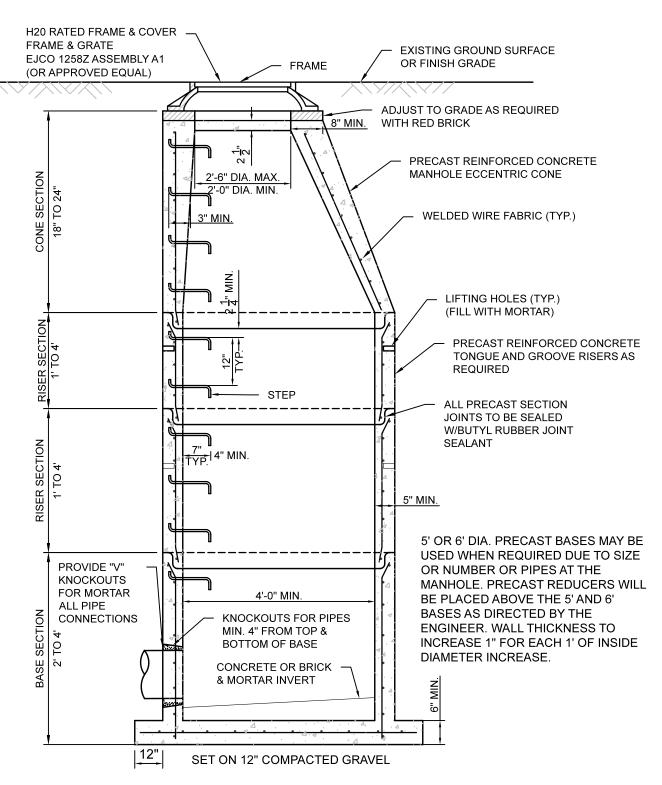

PRECAST DRAIN MANHOLE DETAIL

NOT TO SCALE

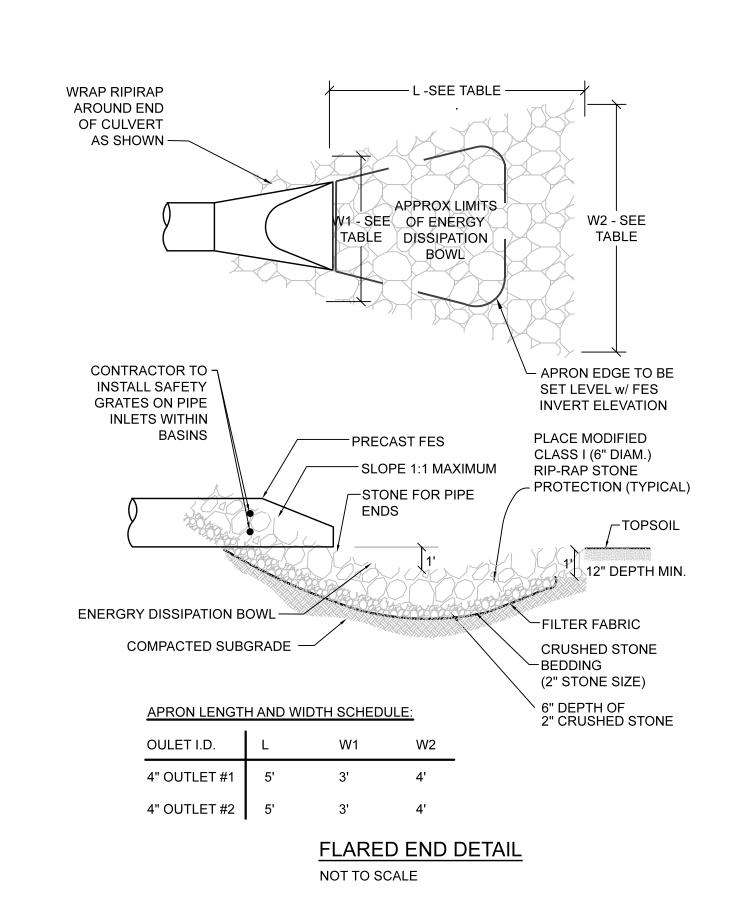

		REVISIONS		
NO.	DATE	DESCRIPTION	ВУ	S
1.	6/5/2023	REVISED PER CON. COMM. SITE WALK	RL	DT
2.	10/19/2023	PER TOWN & PEER REVIEW COMMENTS	MM	DT
က်	3/4/2024	CLIENT CHANGE OF USE/BUILDING	MM	DT
4.	9/4/2024	APPLICANT CHANGE & BUILDING MODIFICATION	MM	DT
5.	11/1/2024	PER TOWN & PEER REVIEW COMMENTS	ММ	DT
9.	2/26/2025	FINAL PEDB ENDORSEMENT SET	MM	DT
7.	3/11/2025	DRAINAGE EASEMENT MODIFICATION	MM	DT



SSOCIATES LLC

MEDWAY, MA 03
RED FOR:

EAST HILL ASSOCIATE


ENGINEERING SERVICES
ENVIRONMENTAL SERVICES


67 Hall Road
Sturbridge, MA 01566
Phone: 774-241-0901
fax: 774-241-0906



ISSUE DATE:	4/12	/2023
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SCALE: NONE		
PROJECT NO.:	2	024-128
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C-5.2



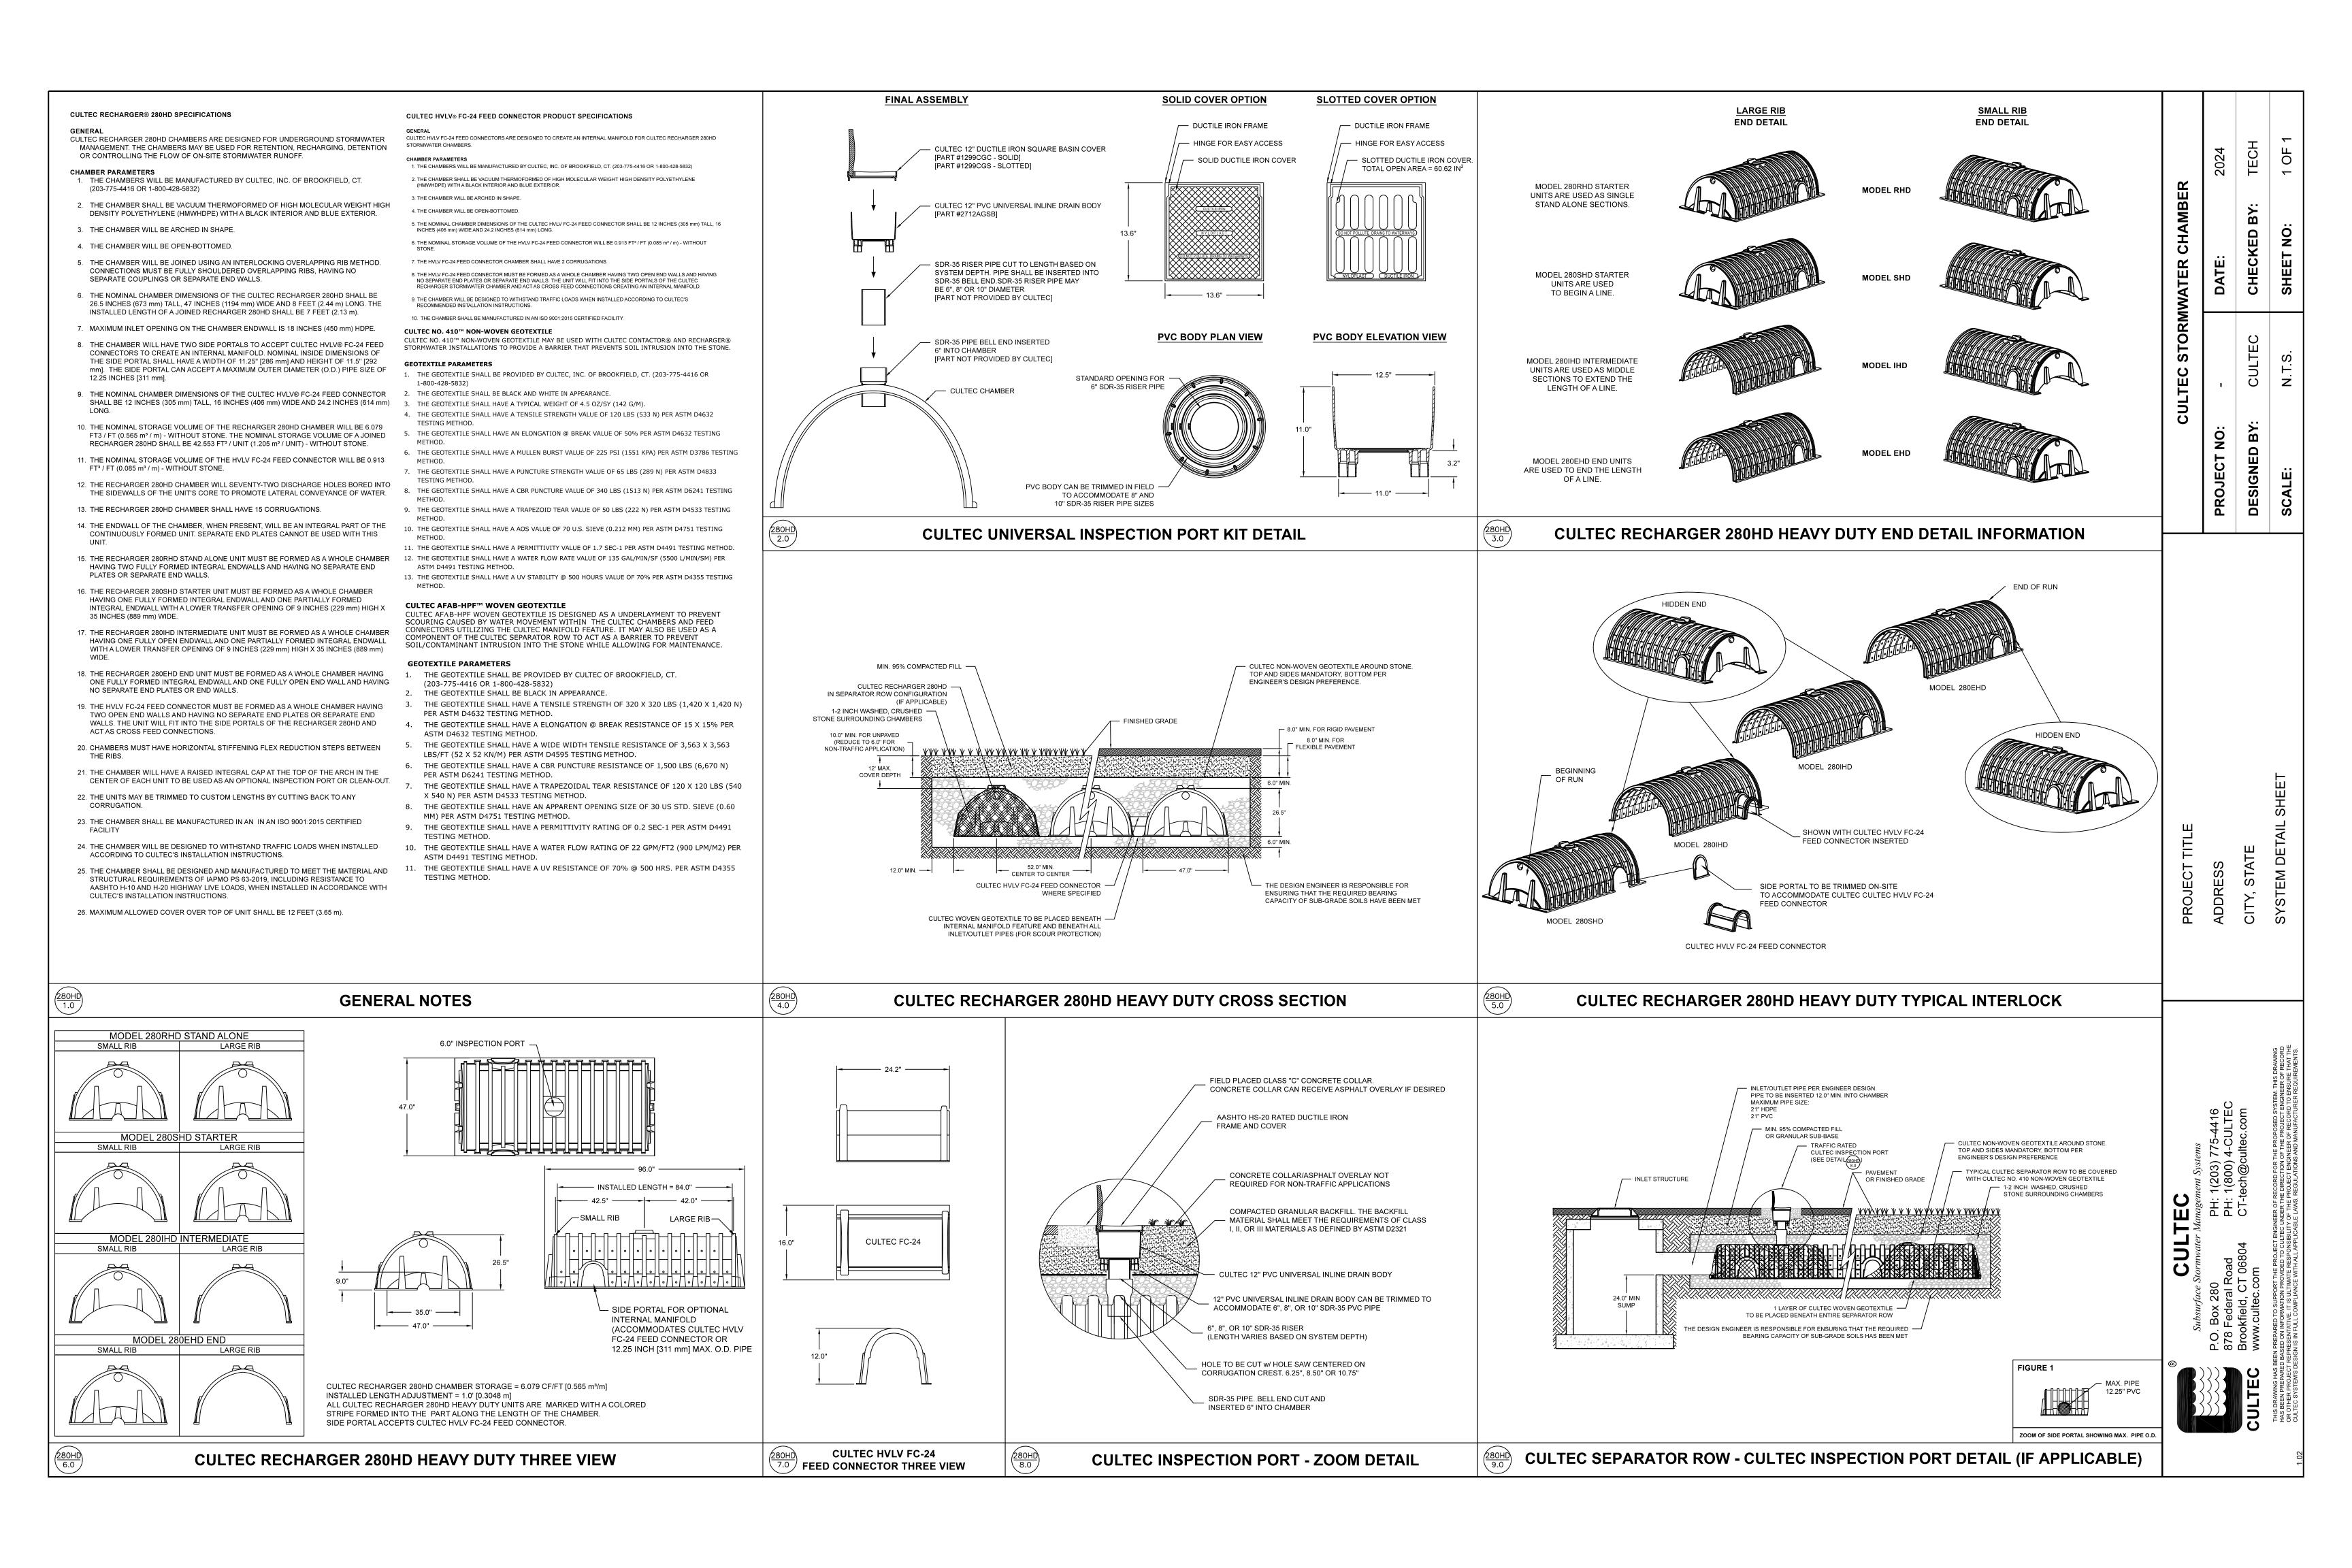


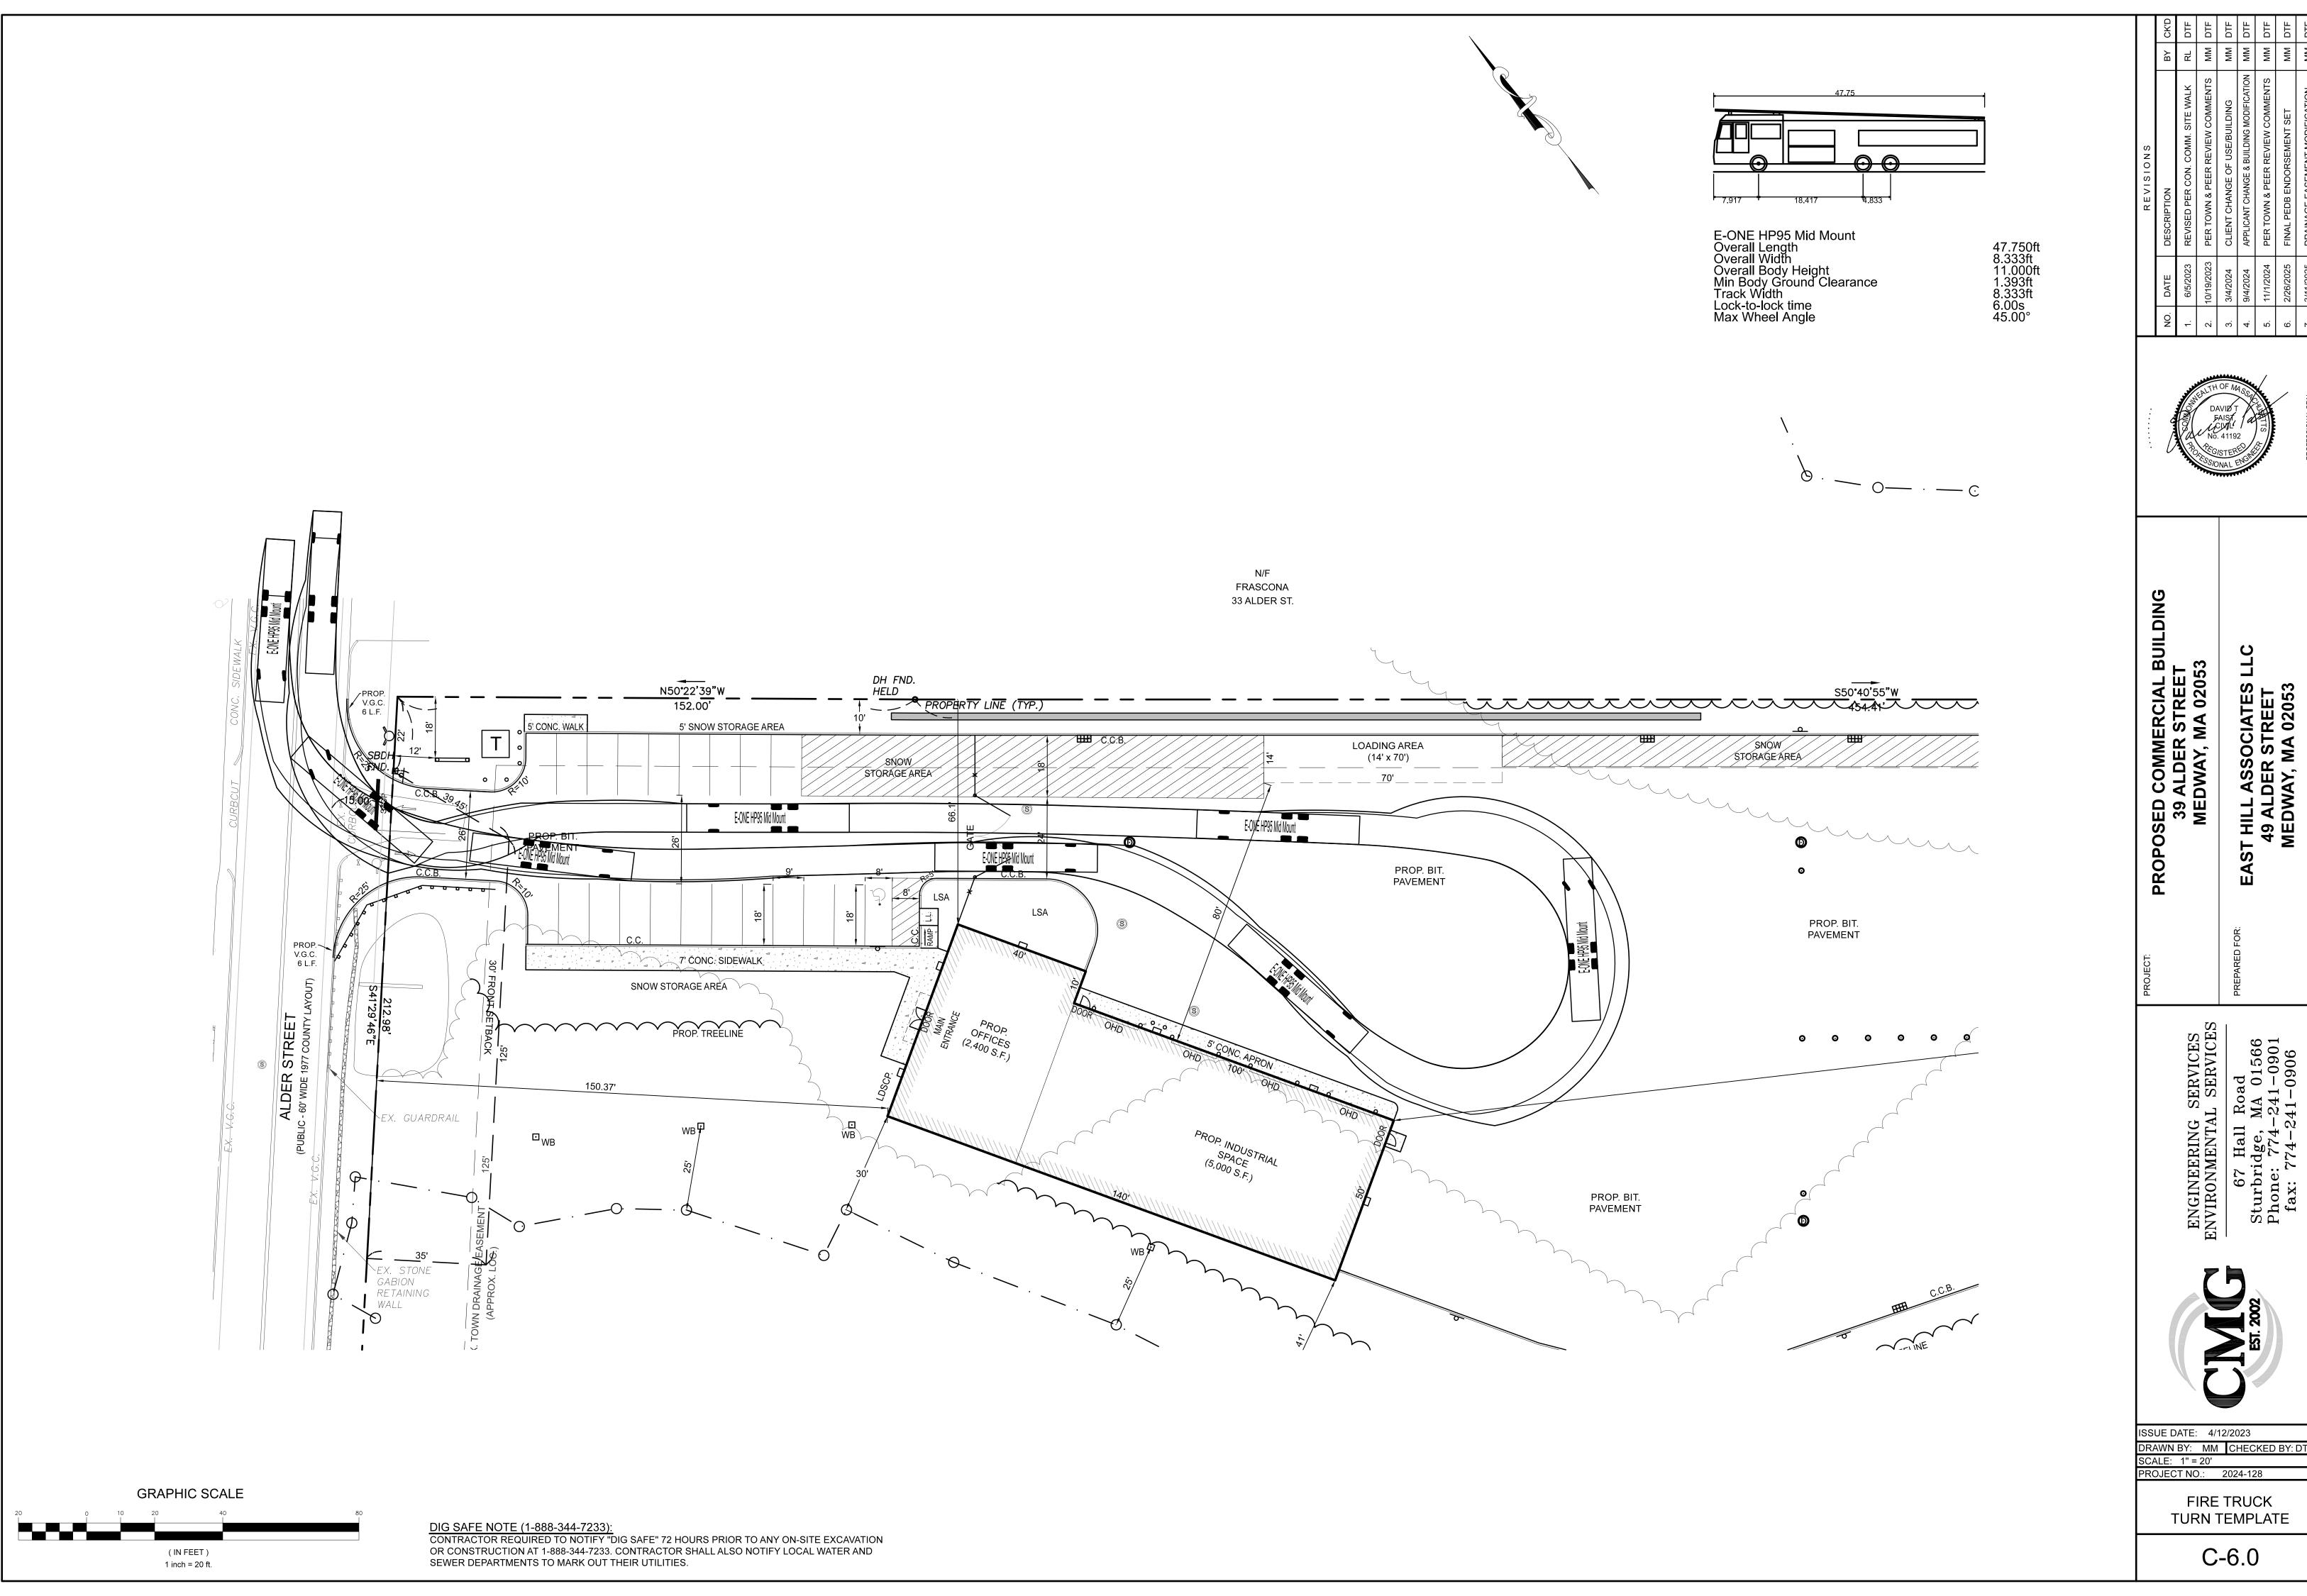


DRAWN BY: MM CHECKED BY: DTF SCALE: 1" = 20' PROJECT NO.: 2024-128

> FIRE TRUCK TURN TEMPLATE

> > C-6.0

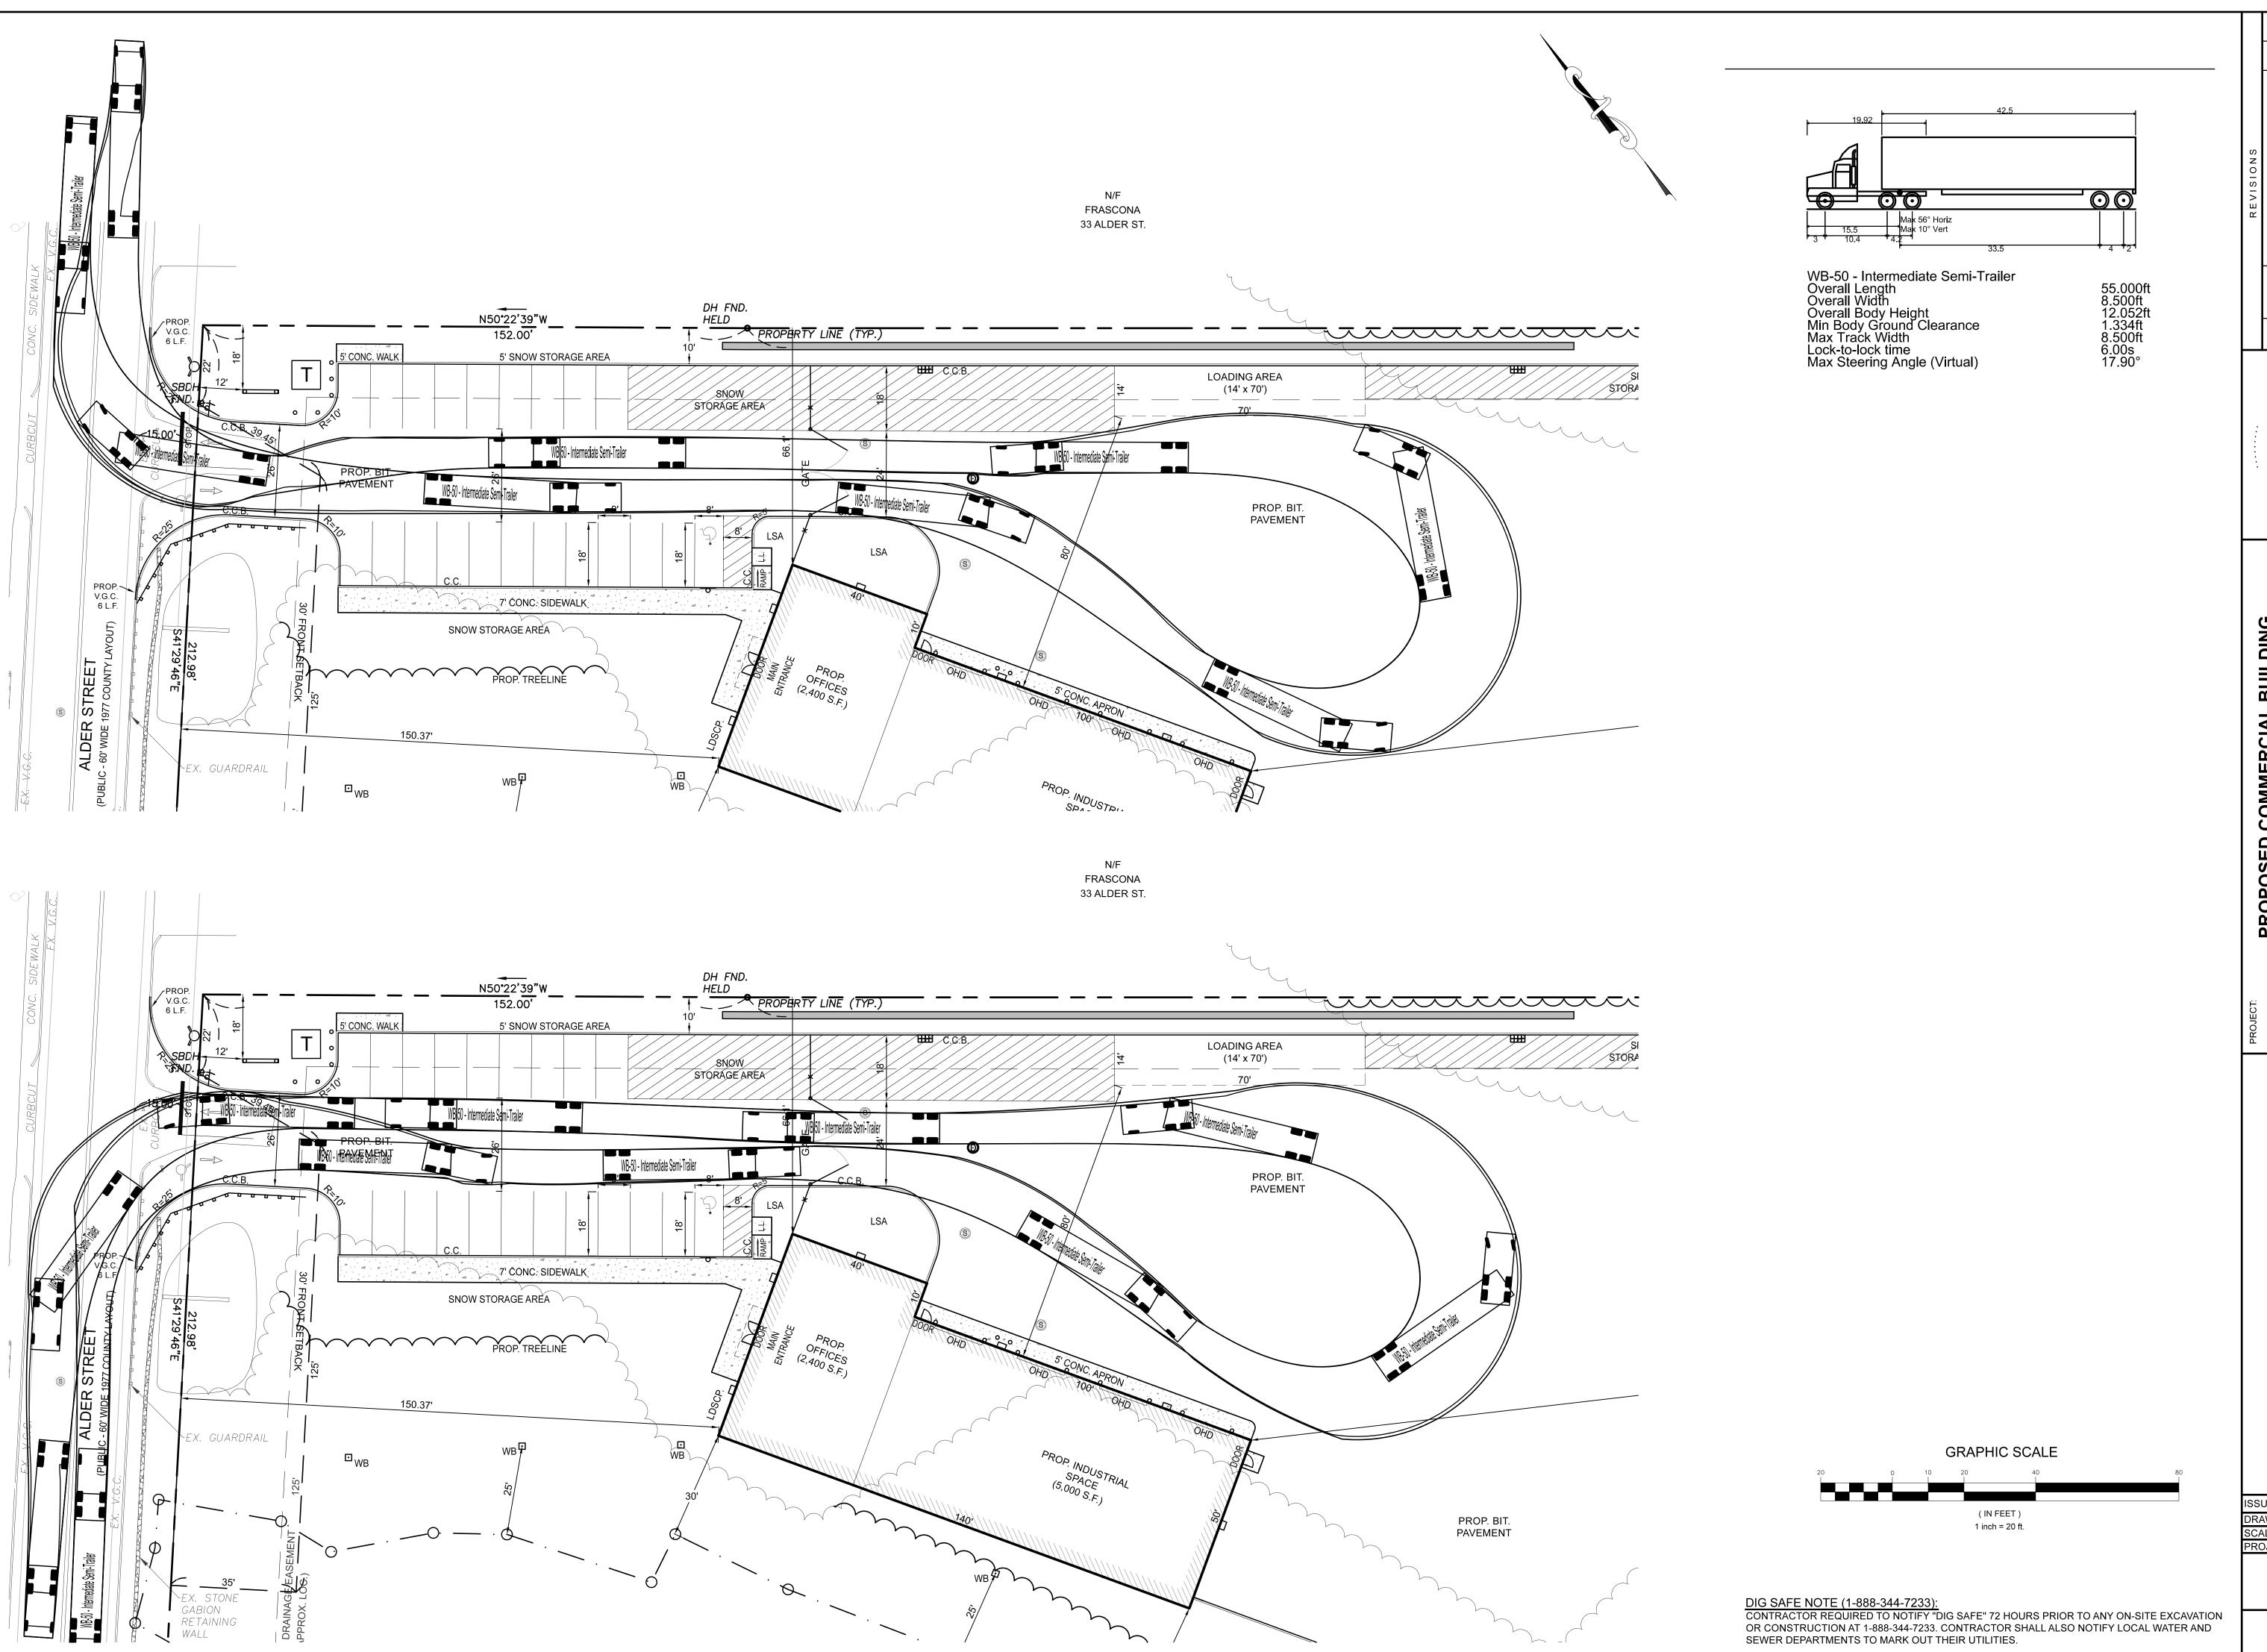

		REVISIONS	DESCRIPTION	REVISED PER CON. COMM. SITE W	PER TOWN & PEER REVIEW COMIN	CLIENT CHANGE OF USE/BUILDING
55.00	Of f		Ш	2023	2023)24

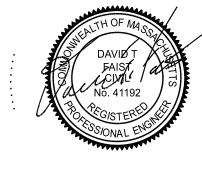

PEGISTERE SSIONAL ENGINEER	

SED COMMERCIAL BUILDING 39 ALDER STREET MEDWAY, MA 02053

- ASSOCIATES I -DER STREET VAY, MA 02053


ENGINEERING SERVICES
ENVIRONMENTAL SERVICES
67 Hall Road
Sturbridge, MA 01566
Phone: 774-241-0901
fax: 774-241-0906




ISSUE DATE: 4/12/2023 DRAWN BY: MM CHECKED BY: DT SCALE: 1" = 20' PROJECT NO.: 2024-128

> WB-50 TRUCK TURN TEMPLATE

> > C-6.1

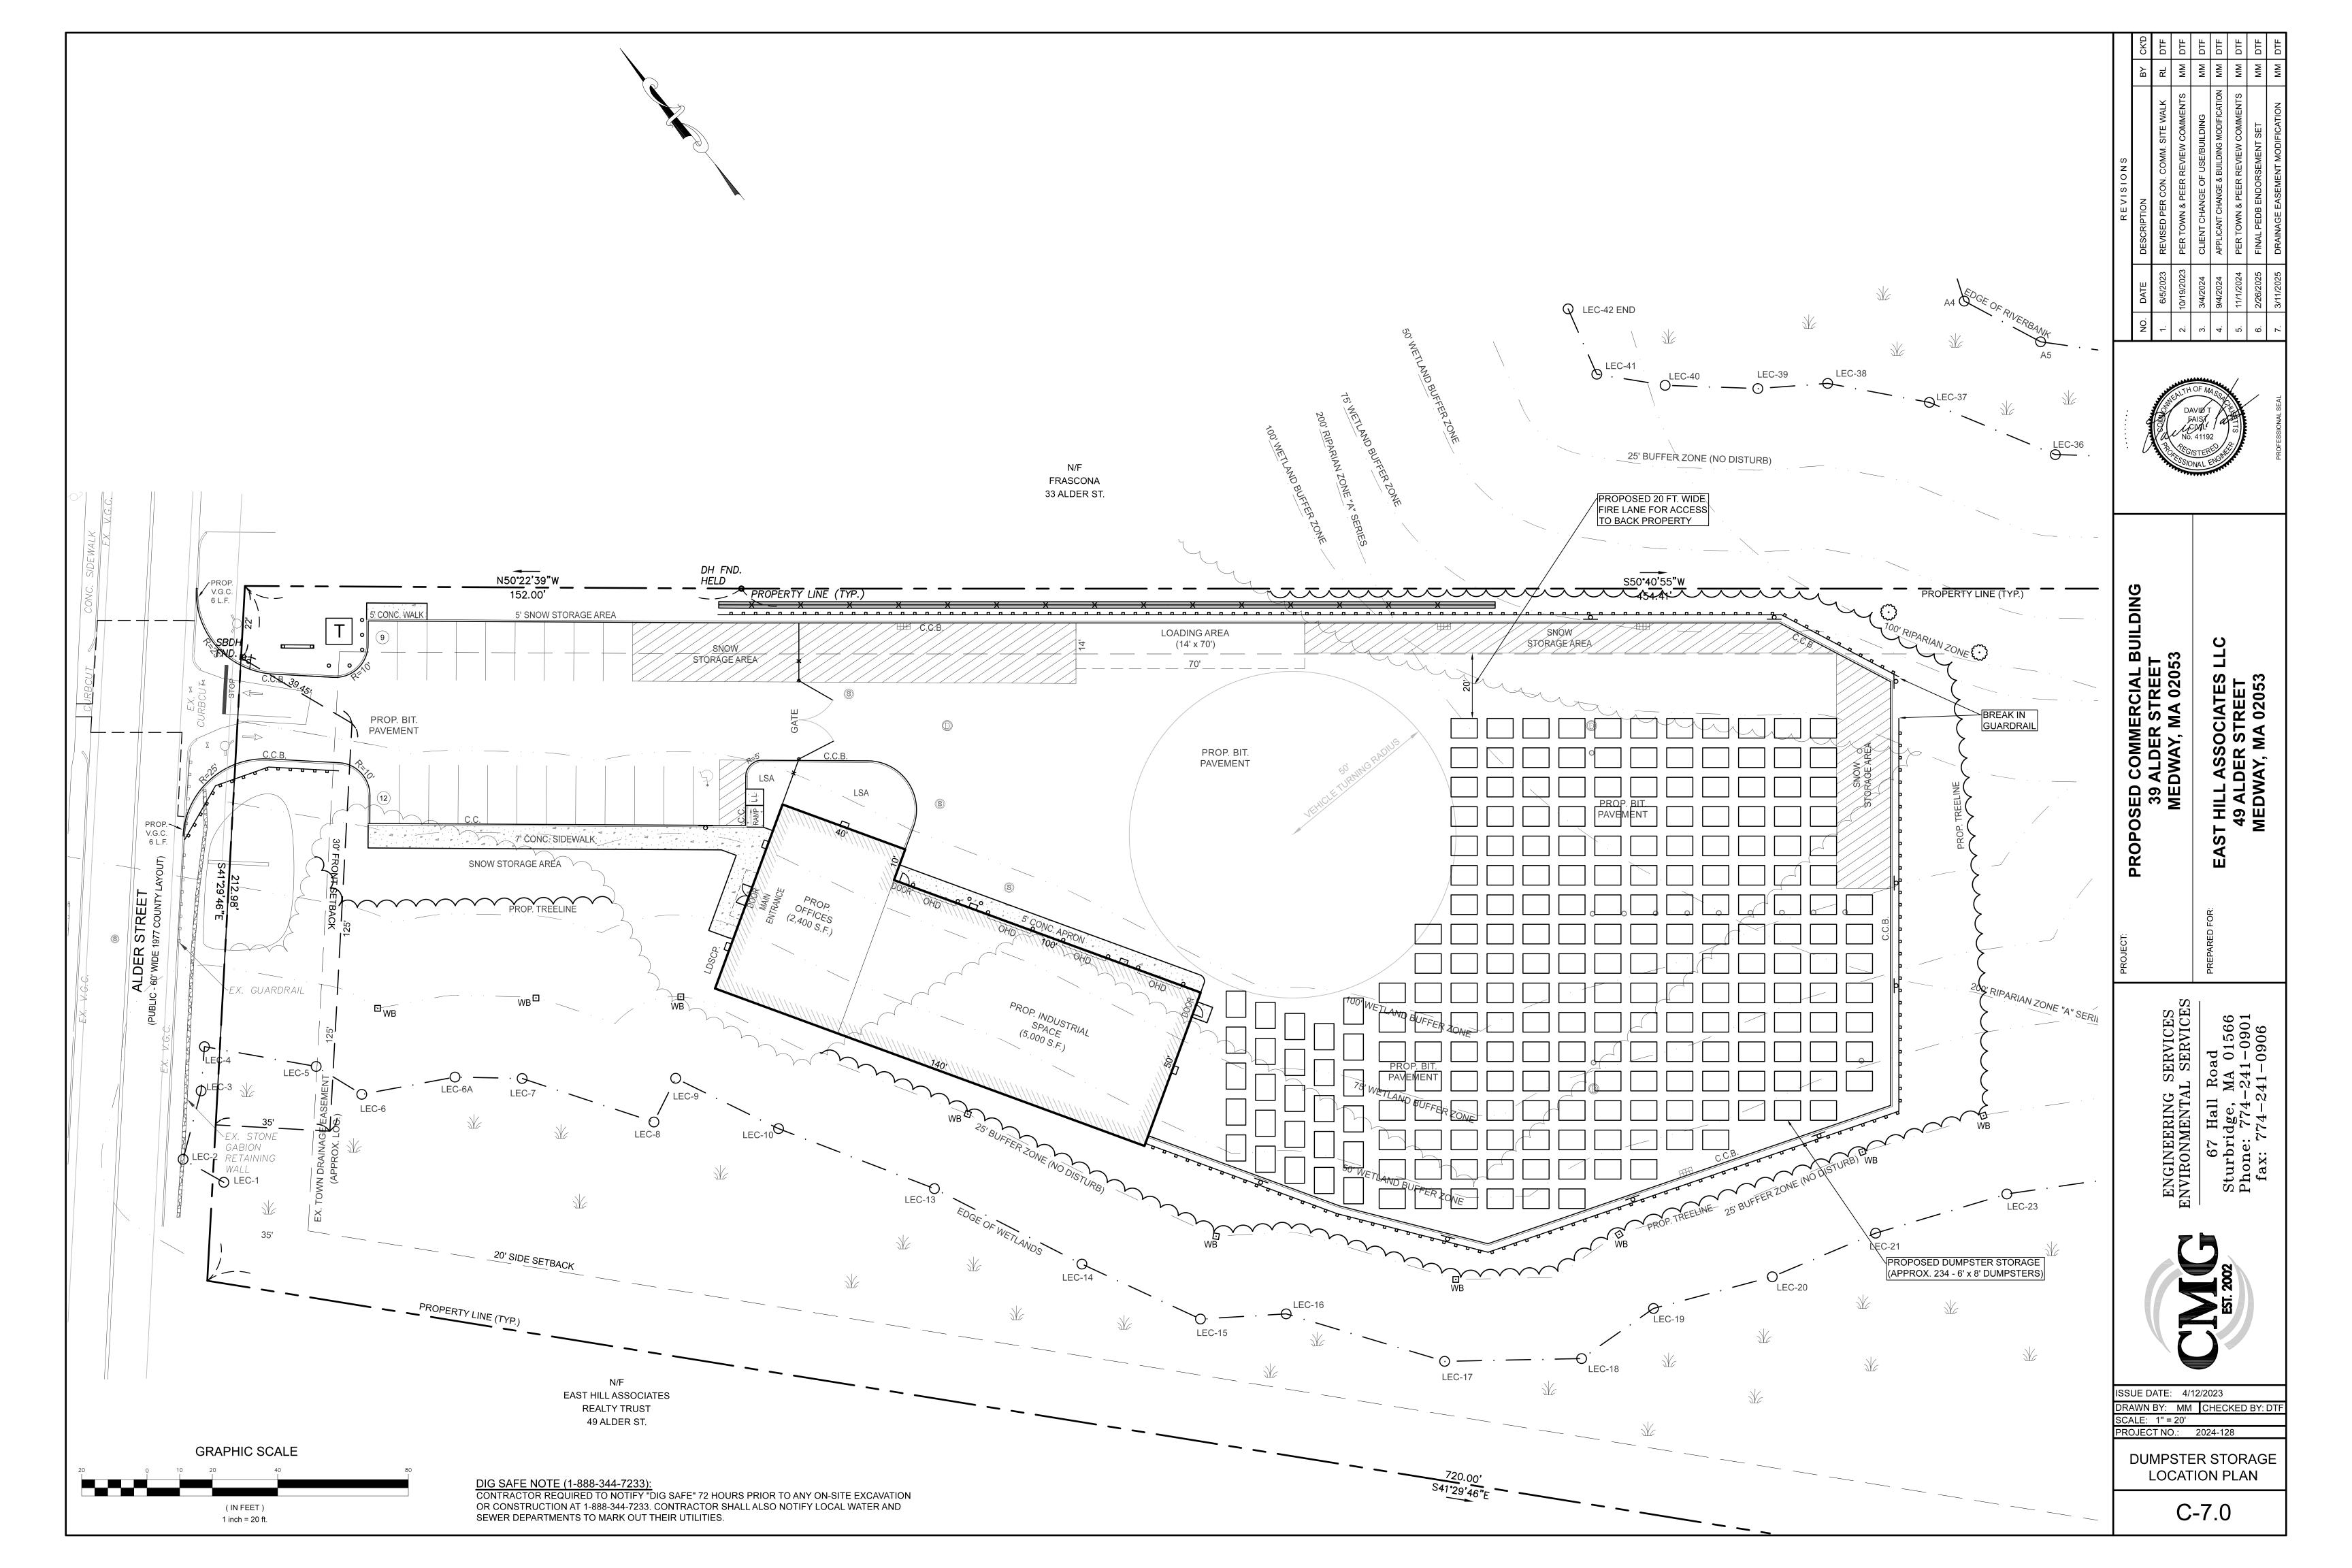

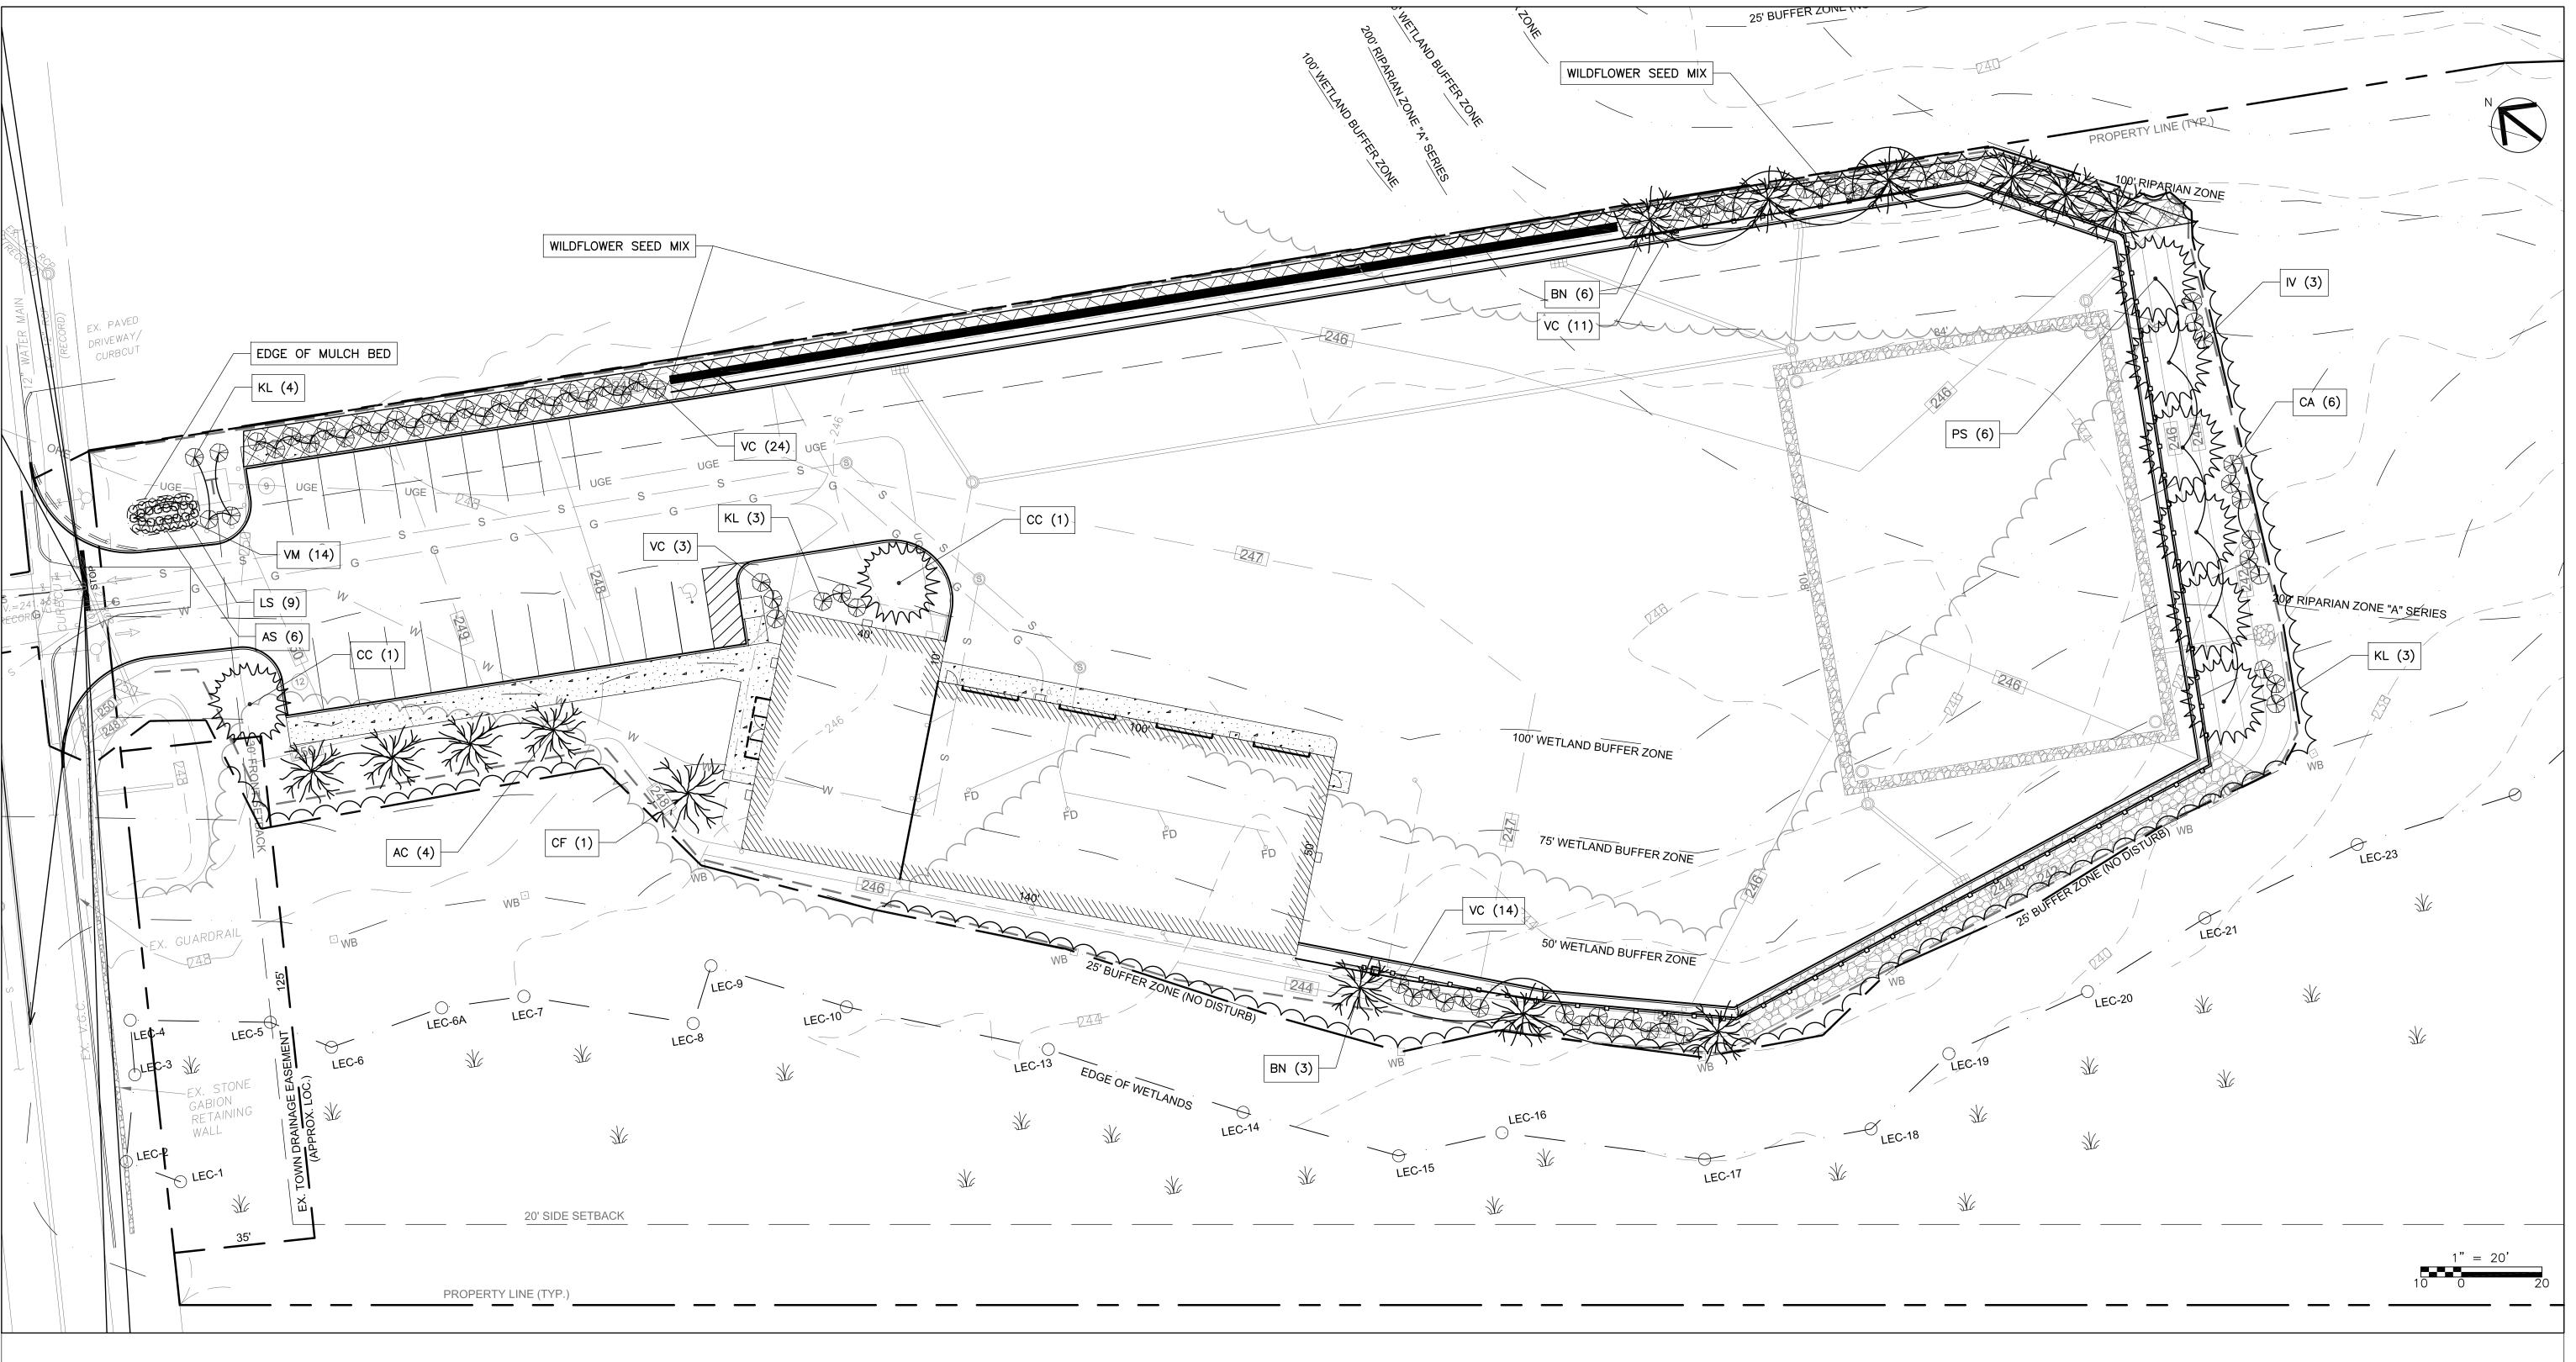

LANDSCAPE NOTE

- LANDSCAPE NOTES

 1. UNLESS OTHERWISE NOTED, ALL EXISTING TREES AND OTHER PLANT MATERIAL TO BE PROTECTED FOR THE DURATION OF THE PROJECT.
- 2. PRIOR TO THE PRE-CONSTRUCTION MEETING, CONTRACTOR SHALL CALL "DIGSAFE" TO HAVE EXISTING UTILITIES MARKED. CONTRACTOR SHALL MAINTAIN MARKINGS FOR THE DURATION OF THE PROJECT
- 3. THE CONTRACTOR SHALL SUPPLY ALL PLANT MATERIAL IN QUANTITIES SUFFICIENT TO COMPLETE THE PLANTING PLAN AS SHOWN ON THE PLANS.
- 4. ALL PLANT MATERIAL TO CONFORM TO THE GUIDELINES ESTABLISHED BY "THE AMERICAN STANDARD FOR NURSERY STOCK" PUBLISHED BY THE AMERICAN ASSOCIATION OF NURSERYMEN, INC. ANSI Z60.1 —LATEST EDITION.
- 5. ALL PLANT MATERIAL TO BE APPROVED BY THE LANDSCAPE ARCHITECT
- 6. STAKE LOCATIONS OF PLANT MATERIAL FOR APPROVAL BY LANDSCAPE ARCHITECT PRIOR TO
- COMMENCEMENT OF WORK.


 7. ALL MULCH BEDS SHALL CONSIST OF A 5" LAYER SCREENED LOAM AND A 3" LAYER SHREDDED
- PINE BARK MULCH.


 8 FDGE OF MULCH REDS TO BE MECHANICALLY FDGED
- 8. EDGE OF MULCH BEDS TO BE MECHANICALLY EDGED.
 9. ALL DISTURBED AREAS NOT SHOWN AS PAVEMENT, MULCH BEDS, OR OTHER SPECIFIED MATERIAL
- SHALL RECEIVE A MINIMUM 5" LAYER OF LOAM AND SEED.

 10. LANDSCAPE CONTRACTOR TO GUARANTEE ALL PLANT MATERIAL FOR TWO FULL YEARS FROM DATE OF ACCEPTANCE.
- 11. CONTRACTOR SHALL REPAIR OR REPLACE ANY MATERIALS DAMAGED DURING CONSTRUCTION PRIOR TO FINAL ACCEPTANCE.
- 12. CONTRACTOR TO SUBMIT A WATERING SCHEDULE FOR THE SIXTY DAY MAINTENANCE PERIOD FOR REVIEW BY THE LANDSCAPE ARCHITECT AND OWNER FOR ALL PROPOSED PLANT MATERIAL.
- 13. SEE LANDSCAPE DETAILS ON SHEET L-2 FOR PLANTING INFORMATION
 14. IN THE EVENT OF A DISCREPANCY BETWEEN THE PLANT QUANTITIES SHOWN ON THE PLAN AND IN
- THE PLANT SCHEDULE, THE QUANTITY SHOWN ON THE PLAN SHALL TAKE PRECEDENCE.

 15. RESTORATION SEED MIX TO BE "NEW ENGLAND SHOWY WILDFLOWER SEED MIX" FROM NEW ENGLAND WETLAND PLANTS, INC. 820 WEST ST. AMHERST MA. (413)—548—8000. SEED MIX TO BE APPLIED BY HYDROSEEDER IN EARLY SPRING OR LATE FALL AS APPROVED BY THE LANDSCAPE ARCHITECT. APPROXIMATE AREA TO RECEIVE SEED MIX 2,100 SQ FT.

	Plant Schedule					
	Symbol	Quantity	Botanical Name	Common Name	Size	Root
	Trees (22 Total)					
3 1 (CF	1	CORNUS FLORIDA	FLOWERING DOGWOOD	2-2.5" CAL.	ВВ
*	AC	4	AMELANCHIER CANADENSIS	SERVICE BERRY	5'-6' H MUL	TI-STEMME
1.8%	BN	9	BETULA NIGRA	RIVER BIRCH	6'-7' HEIGHT	ВВ
Me	СС	2	CERCIS CANADENSIS	EASTERN REDBUD	2-2.5" CAL.	ВВ
mz	PS	6	PINUS STROBUS	UPRIGHT WHITE PINE	6'-7' HEIGHT	ВВ
	Shrubs (71 Total)				
	VC	52	VACCINIUM CORYMBOSUM	HIGHBUSH BLUEBERRY	2'-2.5' H	
∇	KL	10	KALMIA LATIFOLIA	MOUNTAIN LAUREL	2'-2.5' H	COLLECTE
	CA	6	CLETHRA ALNIFOLIA	SUMMERSWEET	2'-2.5' H	
	IV	3	ILEX VERTICILLATA	WINTER RED WINTERBERRY	2'-2.5' H	1 MALE
	Perennials (29 T	otal)				
www.	LS	9	LEUCANTHEMUM X SUPERBUM 'BECKY'	SHASTA DAISY	#2 POT	
my	AS	6	ASTILBE SIMPLICIFOLIA 'WHITE SENSATION'	WHITE SENSATION ASTILBE	#2 POT	
رسر	VM	14	VINCA MINOR	PERIWINKLE	#1 POT	

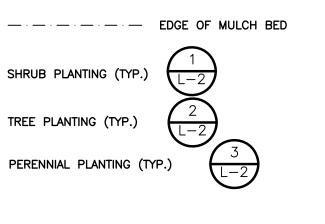


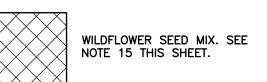



PLANTING PLAN


Proj. No.


L-1

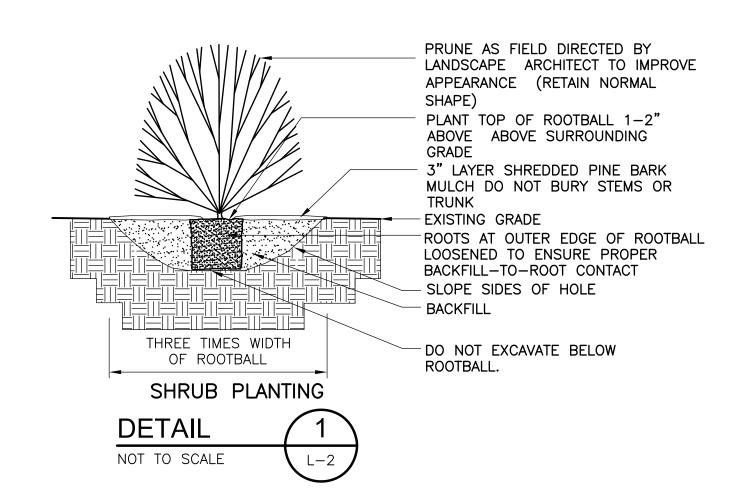

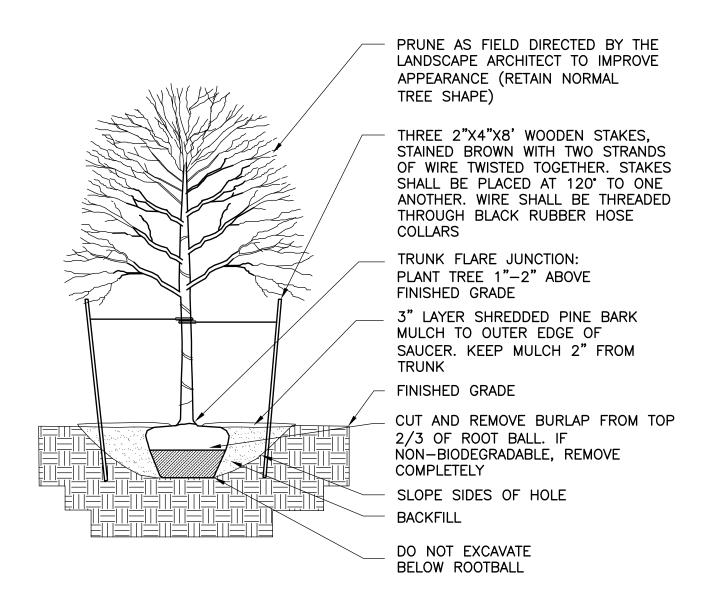

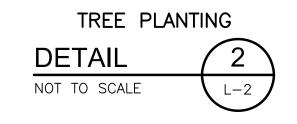

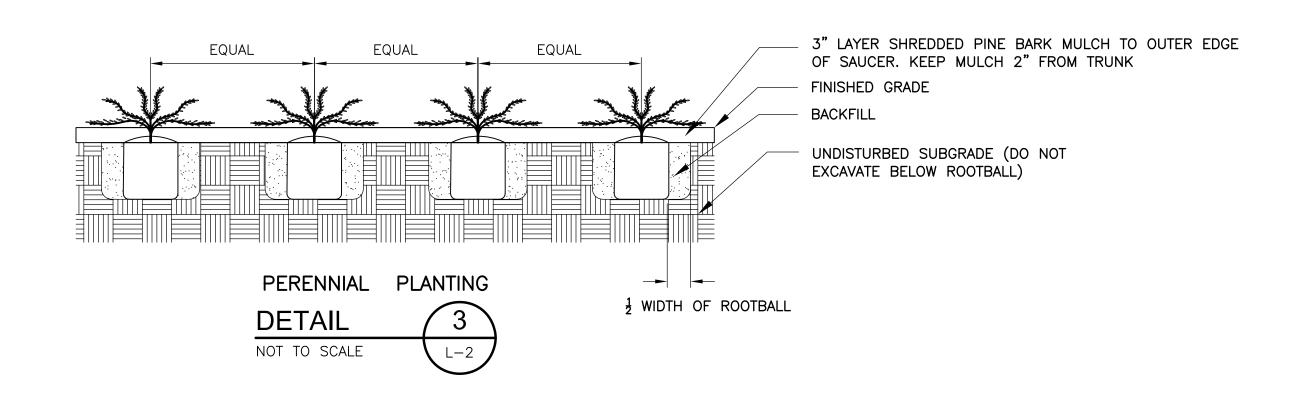

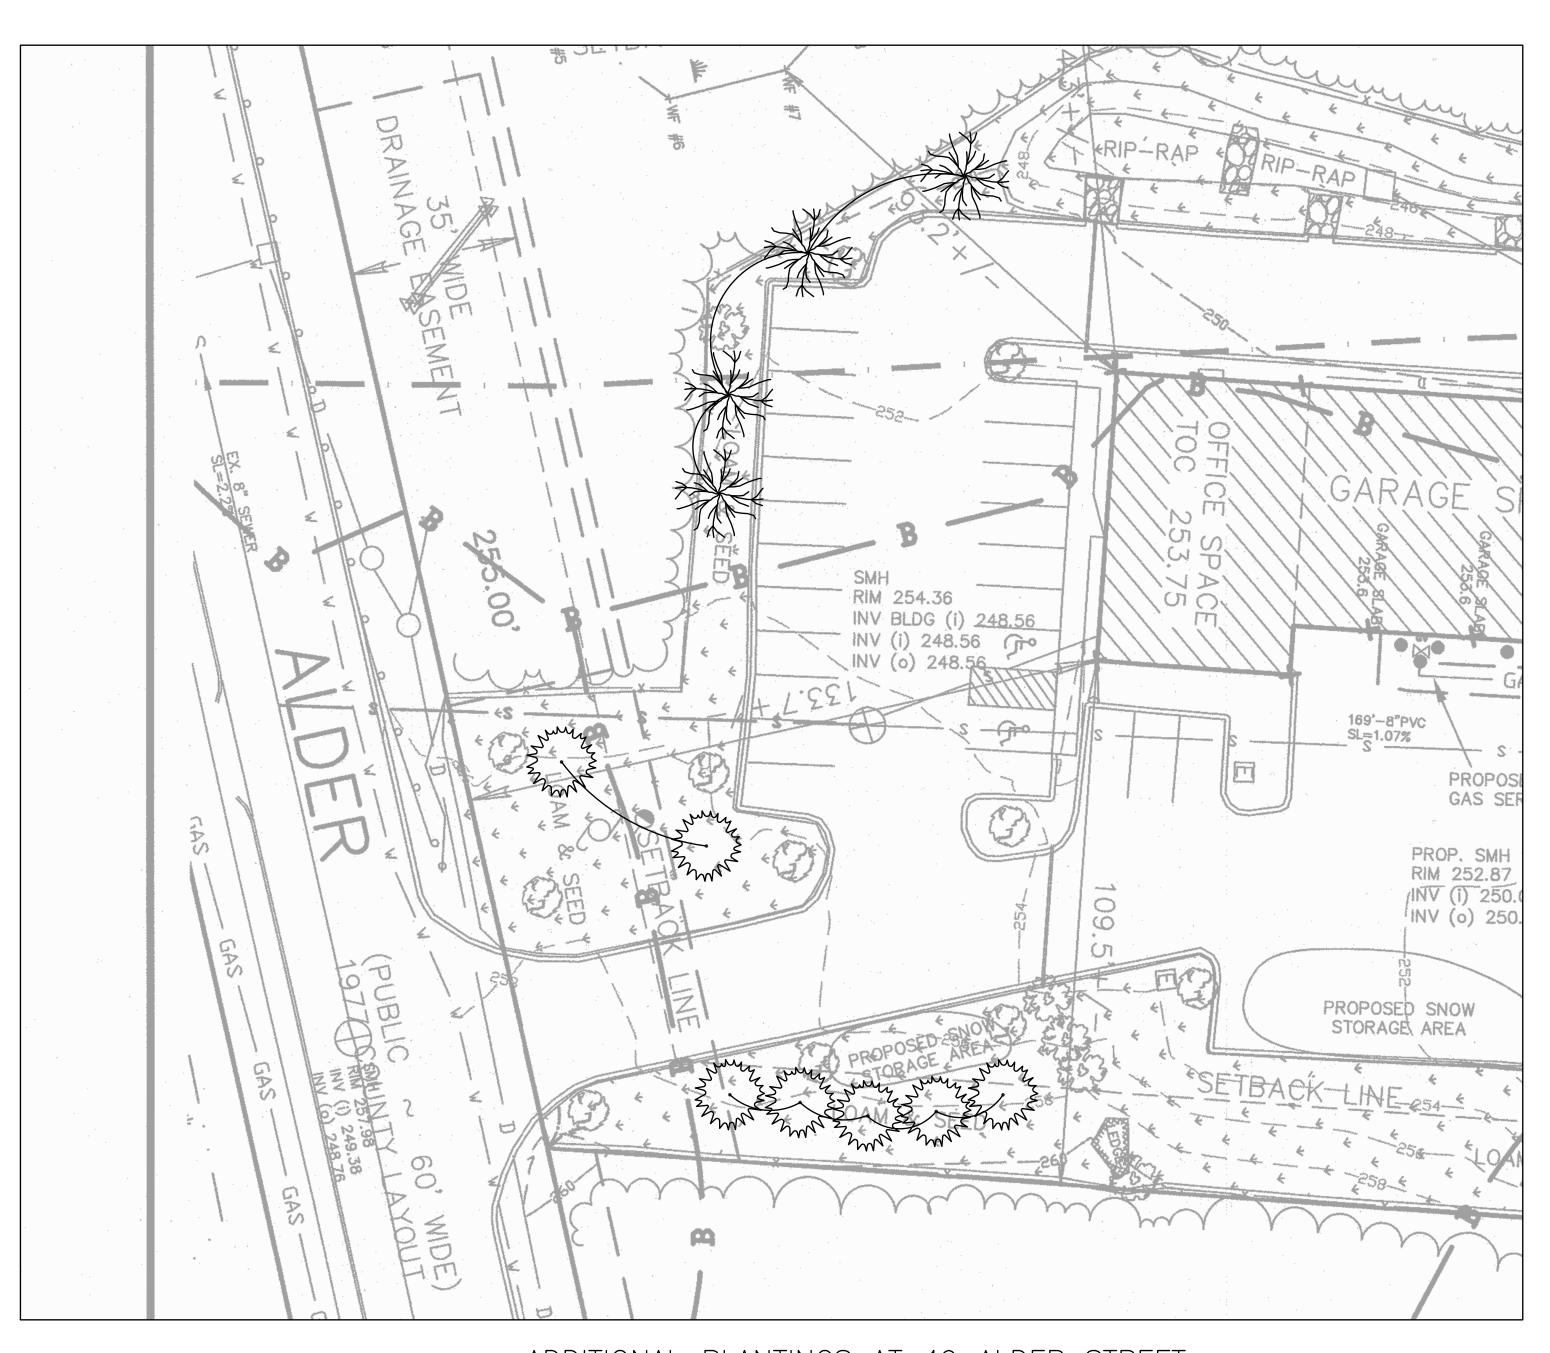

<u>ADDITIONAL PLANTINGS AT 49 ALDER STREET</u>

	Plant Schedule					
	Symbol	Quantity	Botanical Name	Common Name	Size	Root
	Trees (11 Total)					
*	QR	4	QUERCUS RUBRA	RED OAK	2-2.5" CAL.	ВВ
my	JV	7	JUNIPERUS VIRGINIANA	EASTERN RED CEDAR	6'-7' HEIGHT	ВВ

1	DATE BY		CHECKED	CHECKED DESCRIPTION
	8/9/24 JC	JC	DF	APPLICANT CHANGE & BUILDING MODIFICAT
	11/5/24 JC		DF	ADDITIONAL PLANTINGS PER CONCOM COM
ı				
ı				SEVISIONS.






Checked: DF
Scale: AS NOTED

ITING DETAILS
SED COMMERCIAL BUILDING

Proj. No.


Dwg. No.

L-2

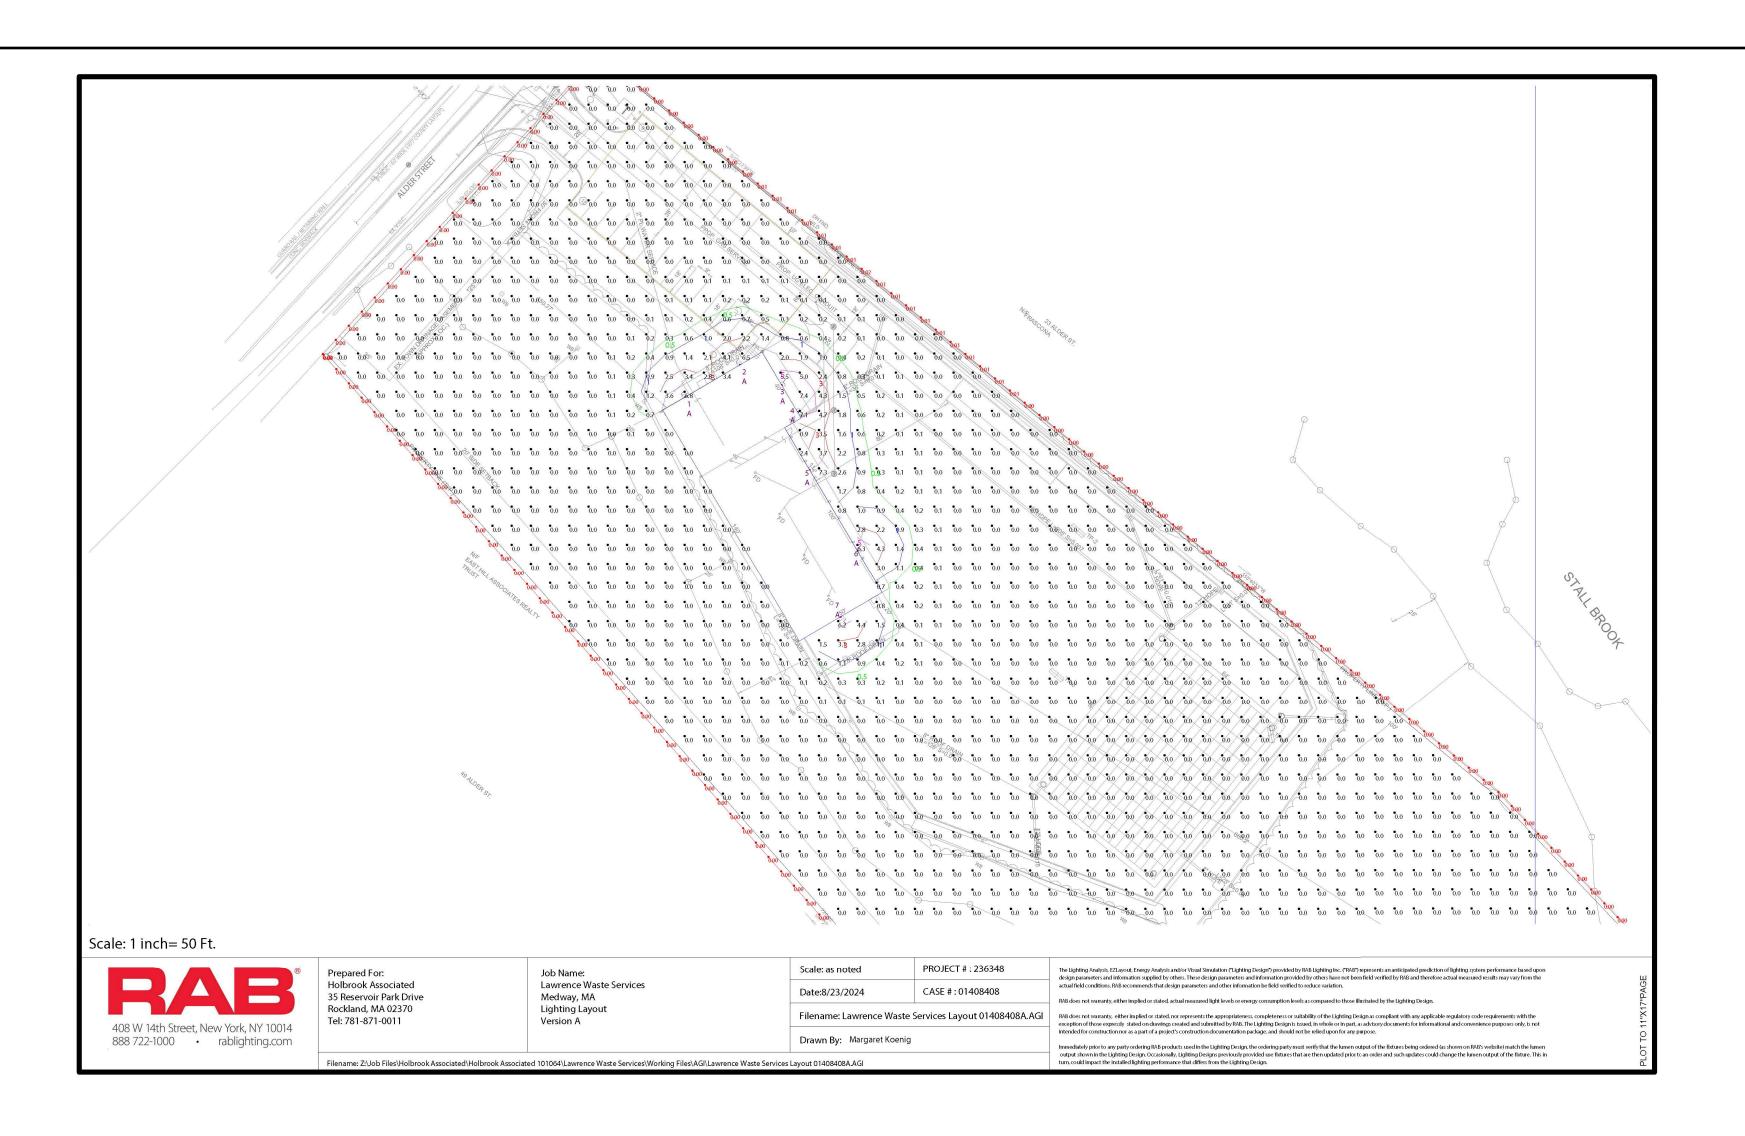

Calculation	on Sumn	nary													
Label			CalcType	Un	its	Avg	Max	Min	Avg/Min	Max/Min	Description	PtSpcLr	PtSpcTb	Meter Type	
Property I	_ine		Illuminance	Fc		0.00	0.02	0.00	N.A.	N.A.	Readings taken at 0'0" AFG	10	N.A.	Horizontal	
Site			Illuminance	Fc		0.06	7.4	0.0	N.A.	N.A.	Readings taken at 0'0" AFG	10	10	Horizontal	
Parking			Illuminance	Fc		0.11	2.2	0.0	N.A.	N.A.	Readings taken at 0'0" AFG				
Luminaire Symbol	e Schedu Qty	ıle Tag	Label	Arrangement	Lum. Lumens	LLF	Description	on					Lum. Watts	Total Watts	BUG
	7	A	SLIMFC37Y	Single	3339	1.000	Wall Mour	nted (Full C	utoff 37W 3	3000K)			35.2	246.4	B1-U

Expanded Luminaire Location Summary MTG HT Orient 190.181 120.501 282.295 218.918 299.222 120.501 240.549 288.753 30.501 249.013 30.792 274.647 255.093 244.41 30.501 279.965 202.137 30.501 271.298 167.594 300.501 Total Quantity: 7

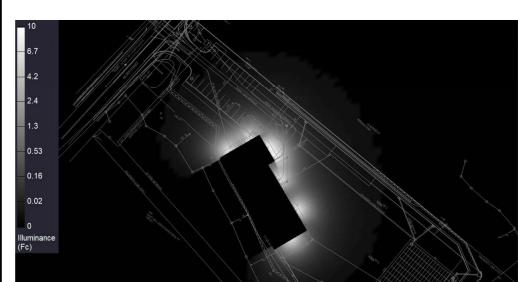

Holbrook Associated

35 Reservoir Park Drive

Rockland, MA 02370

Lawrence Waste Services


Filename: Z:\Job Files\Holbrook Associated\Holbrook Associated 101064\Lawrence Waste Services\Working Files\AGI\Lawrence Waste Services Layout 01408408A.AGI

Medway, MA

Lighting Layout

Plan View

408 W 14th Street, New York, NY 10014 888 722-1000 • rablighting.com

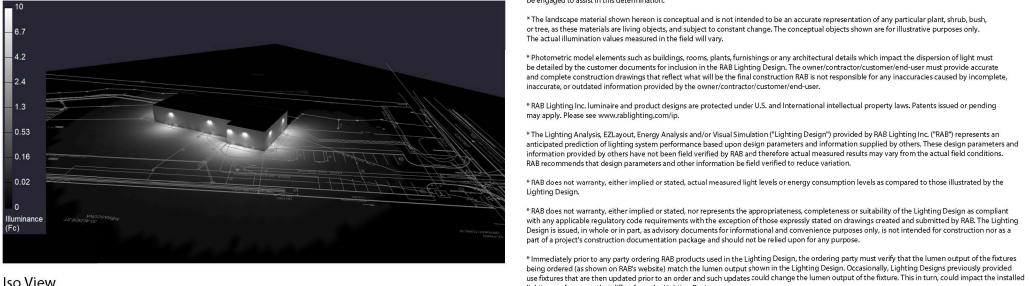

Iso View

PROJECT # : 236348 Scale: as noted Date:8/23/2024 CASE #: 01408408

Filename: Lawrence Waste Services Layout 01408408A.AGI Drawn By: Margaret Koenig

installer's and/or end-user's responsibility based on the weight and effective projected area ("EPA") of the proposed fixtures and the owner's site and soil conditions, wind zone, and many other factors. A professional engineer licensed to practice in the state the site is located should be engaged to assist in this determination. *The landscape material shown hereon is conceptual and is not intended to be an accurate representation of any particular plant, shrub, bush, or tree, as these materials are living objects, and subject to constant change. The conceptual objects shown are for illustrative purposes only. The actual illumination values measured in the field will vary. * Photometric model elements such as buildings, rooms, plants, furnishings or any architectural details which impact the dispersion of light must be detailed by the customer documents for inclusion in the RAB Lighting Design. The owner/contractor/customer/end-user must provide accurate and complete construction drawings that reflect what will be the final construction RAB is not responsible for any inaccuracies caused by incomplete, inaccurate, or outdated information provided by the owner/contractor/customer/end-user. * RAB Lighting Inc. luminaire and product designs are protected under U.S. and International intellectual property laws. Patents issued or pending *The Lighting Analysis, EZLayout, Energy Analysis and/or Visual Simulation ("Lighting Design") provided by RAB Lighting Inc. ("RAB") represents an anticipated prediction of lighting system performance based upon design parameters and information supplied by others. These design parameters and information provided by others have not been field verified by RAB and therefore actual measured results may vary from the actual field conditions. AB recommends that design parameters and other information be field verified to reduce variation. * RAB does not warranty, either implied or stated, actual measured light levels or energy consumption levels as compared to those illustrated by the * RAB does not warranty, either implied or stated, nor represents the appropriateness, completeness or suitability of the Lighting Design as compliant with any applicable regulatory code requirements with the exception of those expressly stated on drawings created and submitted by RAB. The Lighting Design is issued, in whole or in part, as advisory documents for informational and convenience purposes only, is not intended for construction nor as a part of a project's construction documentation package and should not be relied upon for any purpose.

*The light loss factor (LLF) is a product of many variables. RAB's standard is to use the initial 1.0 LLF in accordance with most municipal

* Illumination values shown (in footcandles) are the predicted results for planes of calculation either horizontal, vertical or inclined as designated

* Mounting height determination is job site specific, our lighting simulations assume a mounting height (insertion point of the luminaire symbol) to be taken at the top of the symbol for ceiling mounted luminaires and at the bottom of the symbol for all other luminaire mounting configurations. * RAB disclaims all responsibility for the suitability of existing or proposed poles and bases to support proposed fixtures. This is the owner's,

*The calculated results of this lighting simulation represent an anticipated prediction of system performance. Actual measured results may vary from the anticipated performance and are subject to means and methods which are beyond the control of RAB Lighting Inc.

lighting ordinance light trespass requirements, unless otherwise noted.

in the calculation summary. Meter orientation is normal to the plane of calculation.

lighting performance that differs from the Lighting Design. The Lighting Analysis, EZLayout, Energy Analysis and/or Visual Simulation ("Lighting Design") provided by RAB Lighting Inc. ("RAB") represents an anticipated prediction of lighting system performance based upor design parameters and information provided by others have not been field verified by RAB and therefore actual measured results may vary from the actual field conditions. RAB recommends that design parameters and other information be field verified to reduce variation. $RAB\ does\ not\ warrantly, either\ implied\ or\ stated,\ actual\ measured\ light\ levels\ or\ energy\ consumption\ levels\ as\ compared\ to\ those\ illustrated\ by\ the\ Lightling\ Design.$

RAB does not warranty, either implied or stated, nor represents the appropriateness, completeness or suitability of the Lighting Design as compliant with any applicable regulatory code requirements with the exception of those expressly stated on drawings created and submitted by RAB. The Lighting Design is issued, in whole or in part, as advisory documents for informational and convenience purposes only, is not intended for construction nor as a part of a project's construction documentation package, and should not be relied upon for any purpose. mmediately prior to any party ordering RAB products used in the Lighting Design, the ordering party must verify that the lumen output of the fixtures being ordered (as shown on RAB's website) match the lume output shown in the Lighting Design. Occasionally, Lighting Designs previously provided use fixtures that are then updated prior to an order and such updates could change the lumen output of the fixture. This in turn, could impact the installed lighting performance that differs from the Lighting Design. SLIMFC37Y

RAB

Formulated for high durability and long-lasting color

Mercury and UV free. RoHS compliant components.

LED color temperature is warrantied to shift no more

than 200K in color temperature over a 5 year period

7 step MacAdam Ellipse binning to achieve

consistent fixture to fixture color

Long life, high efficiency, micro power, surface

Green Technology:

LED Characteristics

Color Stability:

Color Consistency:

and knockout pattern for junction box or direct wall impount LEDs; binned and mixed for uniform light



Maximum Ambient Temperature

Suitable for use in up to 40°C (104°F)

Precision die cast aluminum housing and door

Die cast back box with four (4) conduit entry points

Allows for conformance to the IDA's fully shielding

requirement, emitting no light above 90 degrees.

Recommended Mounting Height:

mounting. Hinged housing and buibble level for easy output and color

Technical Specifications

Compliance UL Listed: Suitable for Wet Locations, Wall Mount Only,

Ingress protection rating of IP66 for dust and water IESNA LM-79 & LM-80 Testing:

RABILED luminaires and LED components have been tested by an independent laboratory in accordance with IESNA LM 79 and LM 80. Trade Agreements Act Compliant:

This product is a product of Cambodia and a "designated country" end product that complies with the Trade Agreements Act

Dark Sky Corrformance: Allows for conformance to the IDA's fully shielding requirement, emitting no light above 90 degrees. Construction

Designed to replace RAB HID WP1 wall packs, both in size and footprint template, so upgrading to LED is easy and seamless

Cold Weather Starting: The minimum starting temperature is 40°C (40°F)

installation.

Up to 20 ft

2.84% at 120V, 4.91% at 277V

99.7% at 120V, 94% at 277V

100,000-Hour LED lifespan based on IES LM-80 results and TM-21 calculations


Available accessories include polyshield and wire guard. Click here to see all accessories.

The design of the SLIM™ is protected by patents

pending in US, Canada, China, Taiwan and Mexico

HID Replacement Range:

Buy American Act Compliance:

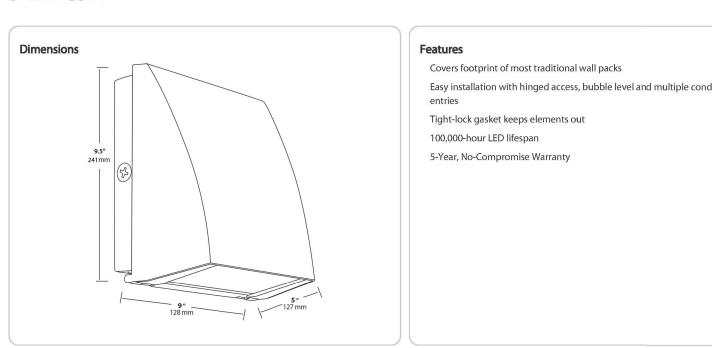

amily	Cutoff	Wattage	Color Temp	Finish	Driver Options	Options	Other Options
SLIM	FC	37	Υ				
	FC = Full Cutoff (0 degrees) Blank = Cutoff (10 degrees)	37 = 37W 57 = 57W 62 = 62W	Blank = 5000K Cool N = 4000K Neutral Y = 3000K Warm	Blank = Bronze W = White	/BL = Bi-Level /480 = 480V /D10 = Dimmable Blank = Standard (120-277V)	Blank = No Option /PC = 120V Button Photocell /PC2 = 277V Button Photocell /PCS = 120V Swivel Photocell /PCS2 = 277V Swivel Photocell /LC = Lightcloud Controller	Blank = Standard USA = BAA Compliant

Technical Specifications (continued)

Power Factor:

Performance

Accessories:

Replaces 200W Metal Halide

RAB warrants that our LED products will be free from defects in materials and workmanship for a period of five (5) years from the date of delivery to the end user, including coverage of light output, color stability, driver performance and fixture finish. RAB's warranty is subject to all terms and conditions found at rablighting.com/warranty.

may be able to manufacture this product to be compliant with the Buy American Act (BAA), Please

BUIL

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ENVIRONMENTAL SERVICES
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Sturbridge, MA 01566
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ISSUE DATE: 4/12/2023 DRAWN BY: MM CHECKED BY: D SCALE: AS NOTED PROJECT NO.: 2024-128 LIGHTING

1 OF 1

PLANS

Electrical Microprismatic diffusion glassiens reduces glare and CIA TRE 02(RAB values USA manufacturing! Upon request, RAB has smooth and even light distribution Constant Current, Class 2, 120 277V, 50 60Hz, 120V: 0.34A, 208V; 0.17A, 240V; 0.17A, 277V; 0.15A contact customer service to request a quote for the Specular thermoplastic Dimming Driver: product to be made BAA compliant. Driver includes dimming control wiring for 0.10V d imming systems. Requires separate 0-10V DC Optical The unique design of the tight lock gasket ensures d in ming circuit. Dims down to 10%. **BUG Rating:** no water or environmental elements will ever get B1 U0 G0 inside the SLIM iii ω ≥ RAB SLIMFC37Y Easy installation with hinged access, bubble level and multiple conduit

